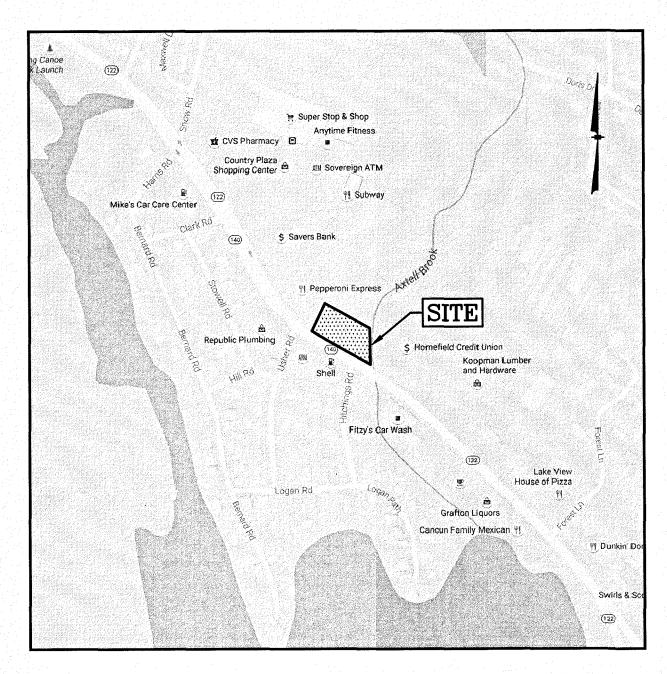
PROPOSED SITE IMPROVEMENT PLANS

for Assessors Map 55 Lot 94 88 Worcester Street Grafton, Massachusetts Prepared for:

Petrogas Group New England, Inc.

168 North Main Street Andover, Massachusetts 01810



LOCUS PLAN

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INDEX TO DRAWINGS

- TITLE SHEET
 - **EXISTING CONDITIONS PLAN**
- **DEMOLITION PLAN**
- SITE PLAN
- GRADING, DRAINAGE, & UTILITIES PLAN
- **EROSION AND SEDIMENT CONTROL PLAN**
- LANDSCAPE PLAN
- **DETAIL SHEET**
- **DETAIL SHEET**
- **DETAIL SHEET**
- 1 OF 1. TRUCK TURN PLAN
- 1 OF 2. LIGHTING PLAN (RL-4770-S1-R1)
- 2 OF 2. LIGHTING DETAILS (RL-4770-S1-R1)
- 1 OF 2. BUILDING ELEVATIONS (A101)
- 2 OF 2. BUILDING ELEVATIONS (A102)
- 1 OF 1. RETAIL FUEL CANOPY ELEVATIONS

| | | | | REVISION | ONS | | | |
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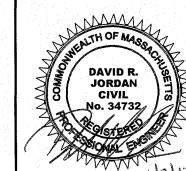
TITLE SHEET

ASSESSORS MAP 55 LOT 94 88 WORCESTER STREET GRAFTON, MASSACHUSETTS

PETROGAS GROUP NEW ENGLAND, INC. 168 NORTH MAIN STREET

ANDOVER, MASSACHUSETTS 01810


| OVED BY THE GRAFTON, MA PLANNING BOARD ON: | - 19 (1) (1) (1) (1) (1) (1) (1) (1) (1) (1) |
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Salem, New Hampshire 03079 **ENGINEERS • PLANNERS • SURVEYORS**

DATE: NOVEMBER 7, 2017 SCALE: NTS SHEET NO. DRAWN BY: CHECKED BY: PROJECT NO. 408816 1 OF 10



(IN FEET)

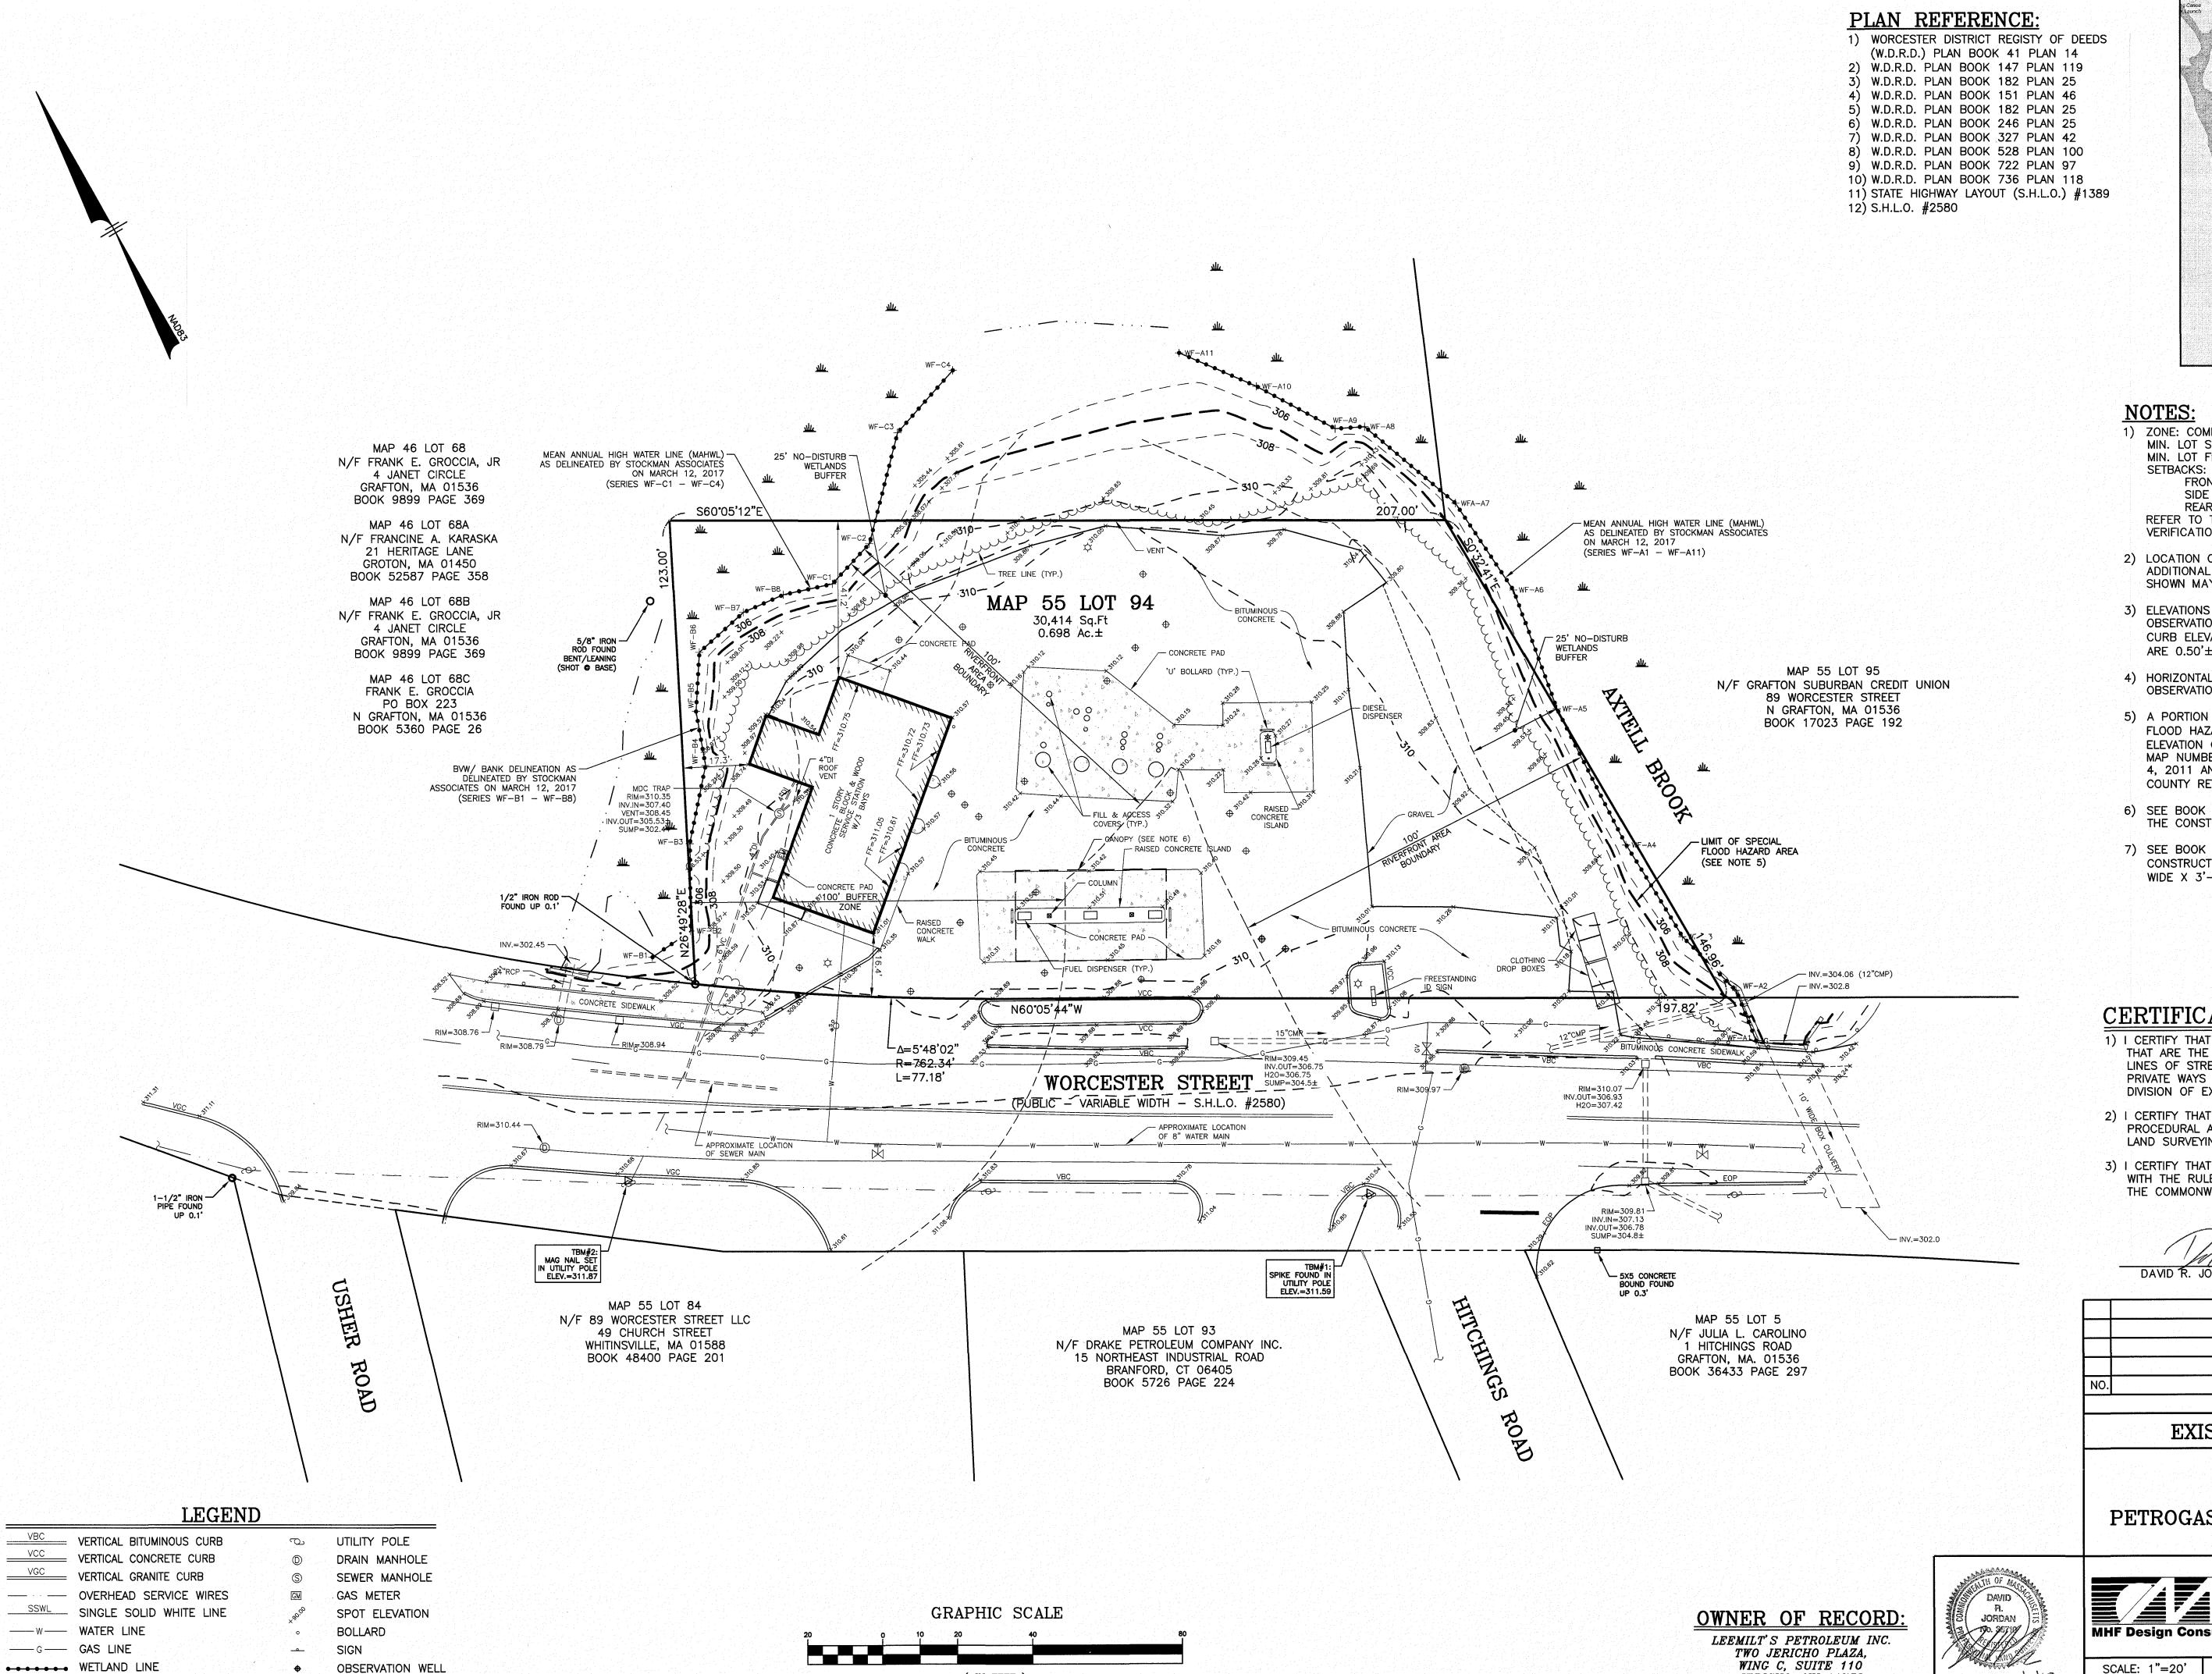1 inch = 20 ft.

> Super Stop & Shop tt CVS Pharmacy 🗗 🔳 🧸 лы Sovereign ATM

LOCATION MAP (NOT TO SCALE)

1) ZONE: COMMUNITY BUSINESS (CB) DISTRICT MIN. LOT SIZE: 40,000 Sq.Ft. MIN. LOT FRONTAGE: 140 Ft.

FRONT 40 Ft. 15 Ft.

REFER TO THE TOWN OF GRAFTON ZONING ORDINANCE FOR VERIFICATION, ADDITIONAL RESTRICTIONS AND PERMITTED USES.

- 2) LOCATION OF UNDERGROUND UTILITIES IS APPROXIMATE ONLY. ADDITIONAL UNDERGROUND UTILITIES OTHER THAN THOSE SHOWN MAY BE ENCOUNTERED.
- 3) ELEVATIONS SHOWN HEREON ARE BASED ON NAVD88 PER GPS OBSERVATIONS PERFORMED BY THIS OFFICE ON MAY 17, 2017. CURB ELEVATIONS SHOWN ARE AT THE "TOE" OF CURB. CURBS ARE 0.50'± HIGH.
- 4) HORIZONTAL DATUM IS BASED ON NAD83 PER GPS OBSERVATIONS PERFORMED BY THIS OFFICE ON MAY 17, 2017.
- 5) A PORTION OF MAP 55 LOT 94 IS LOCATED WITHIN A SPECIAL FLOOD HAZARD AREA (100 YEAR FLOOD) WITH A BASE FLOOD ELEVATION OF 307.1 (NAVD88) PER FLOOD INSURANCE RATE MAP NUMBER 25027C0829E WITH AN EFFECTIVE DATE OF JULY 4, 2011 AND THE FLOOD INSURANCE STUDY OF WORCESTER COUNTY REVISED JULY 16, 2014 (FLOOD PROFILE 10P).
- 6) SEE BOOK 16733 PAGE 390 FOR VARIANCE GRANTED TO ALLOW THE CONSTRUCTION OF A CANOPY.
- 7) SEE BOOK 10029 PAGE 37 FOR VARIANCE GRANTING THE CONSTRUCTION OF A SIGN WHOSE DIMENSIONS ARE 8'-2-1/2" WIDE X 3'-7" HIGH TO BE ERECTED AND CHANGED.

CERTIFICATIONS:

- 1) I CERTIFY THAT THIS SURVEY PLAN SHOWS THE PROPERTY LINES THAT ARE THE LINES OF EXISTING OWNERSHIPS AND THAT THE LINES OF STREETS AND WAYS SHOWN ARE THOSE OF PUBLIC OR PRIVATE WAYS ALREADY ESTABLISHED, THAT NO NEW LINES FOR DIVISION OF EXISTING OWNERSHIP OR FOR NEW WAYS ARE SHOWN.
- 2) I CERTIFY THAT THIS SURVEY AND PLAN CONFORMS TO THE ETHICAL, PROCEDURAL AND TECHNICAL STANDARDS FOR THE PRACTICE OF LAND SURVEYING IN THE COMMONWEALTH OF MASSACHUSETTS.
- 3) I CERTIFY THAT THIS PLAN HAS BEEN PREPARED IN CONFORMANCE WITH THE RULES AND REGULATIONS OF THE REGISTER OF DEEDS OF THE COMMONWEALTH OF MASSACHUSETTS.

DATE DAVID R. JORDAN, P.L.S. DATE DESCRIPTION

REVISIONS

EXISTING CONDITIONS PLAN

ASSESSORS MAP 55 LOT 94 88 WORCESTER STREET GRAFTON, MASSACHUSETTS PREPARED FOR:

PETROGAS GROUP NEW ENGLAND, INC.

168 NORTH MAIN STREET

ANDOVER, MASSACHUSETTS 01810



11/2/17

JERICHO, NY 11753

BOOK 30031 PAGE 198

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11/1/17

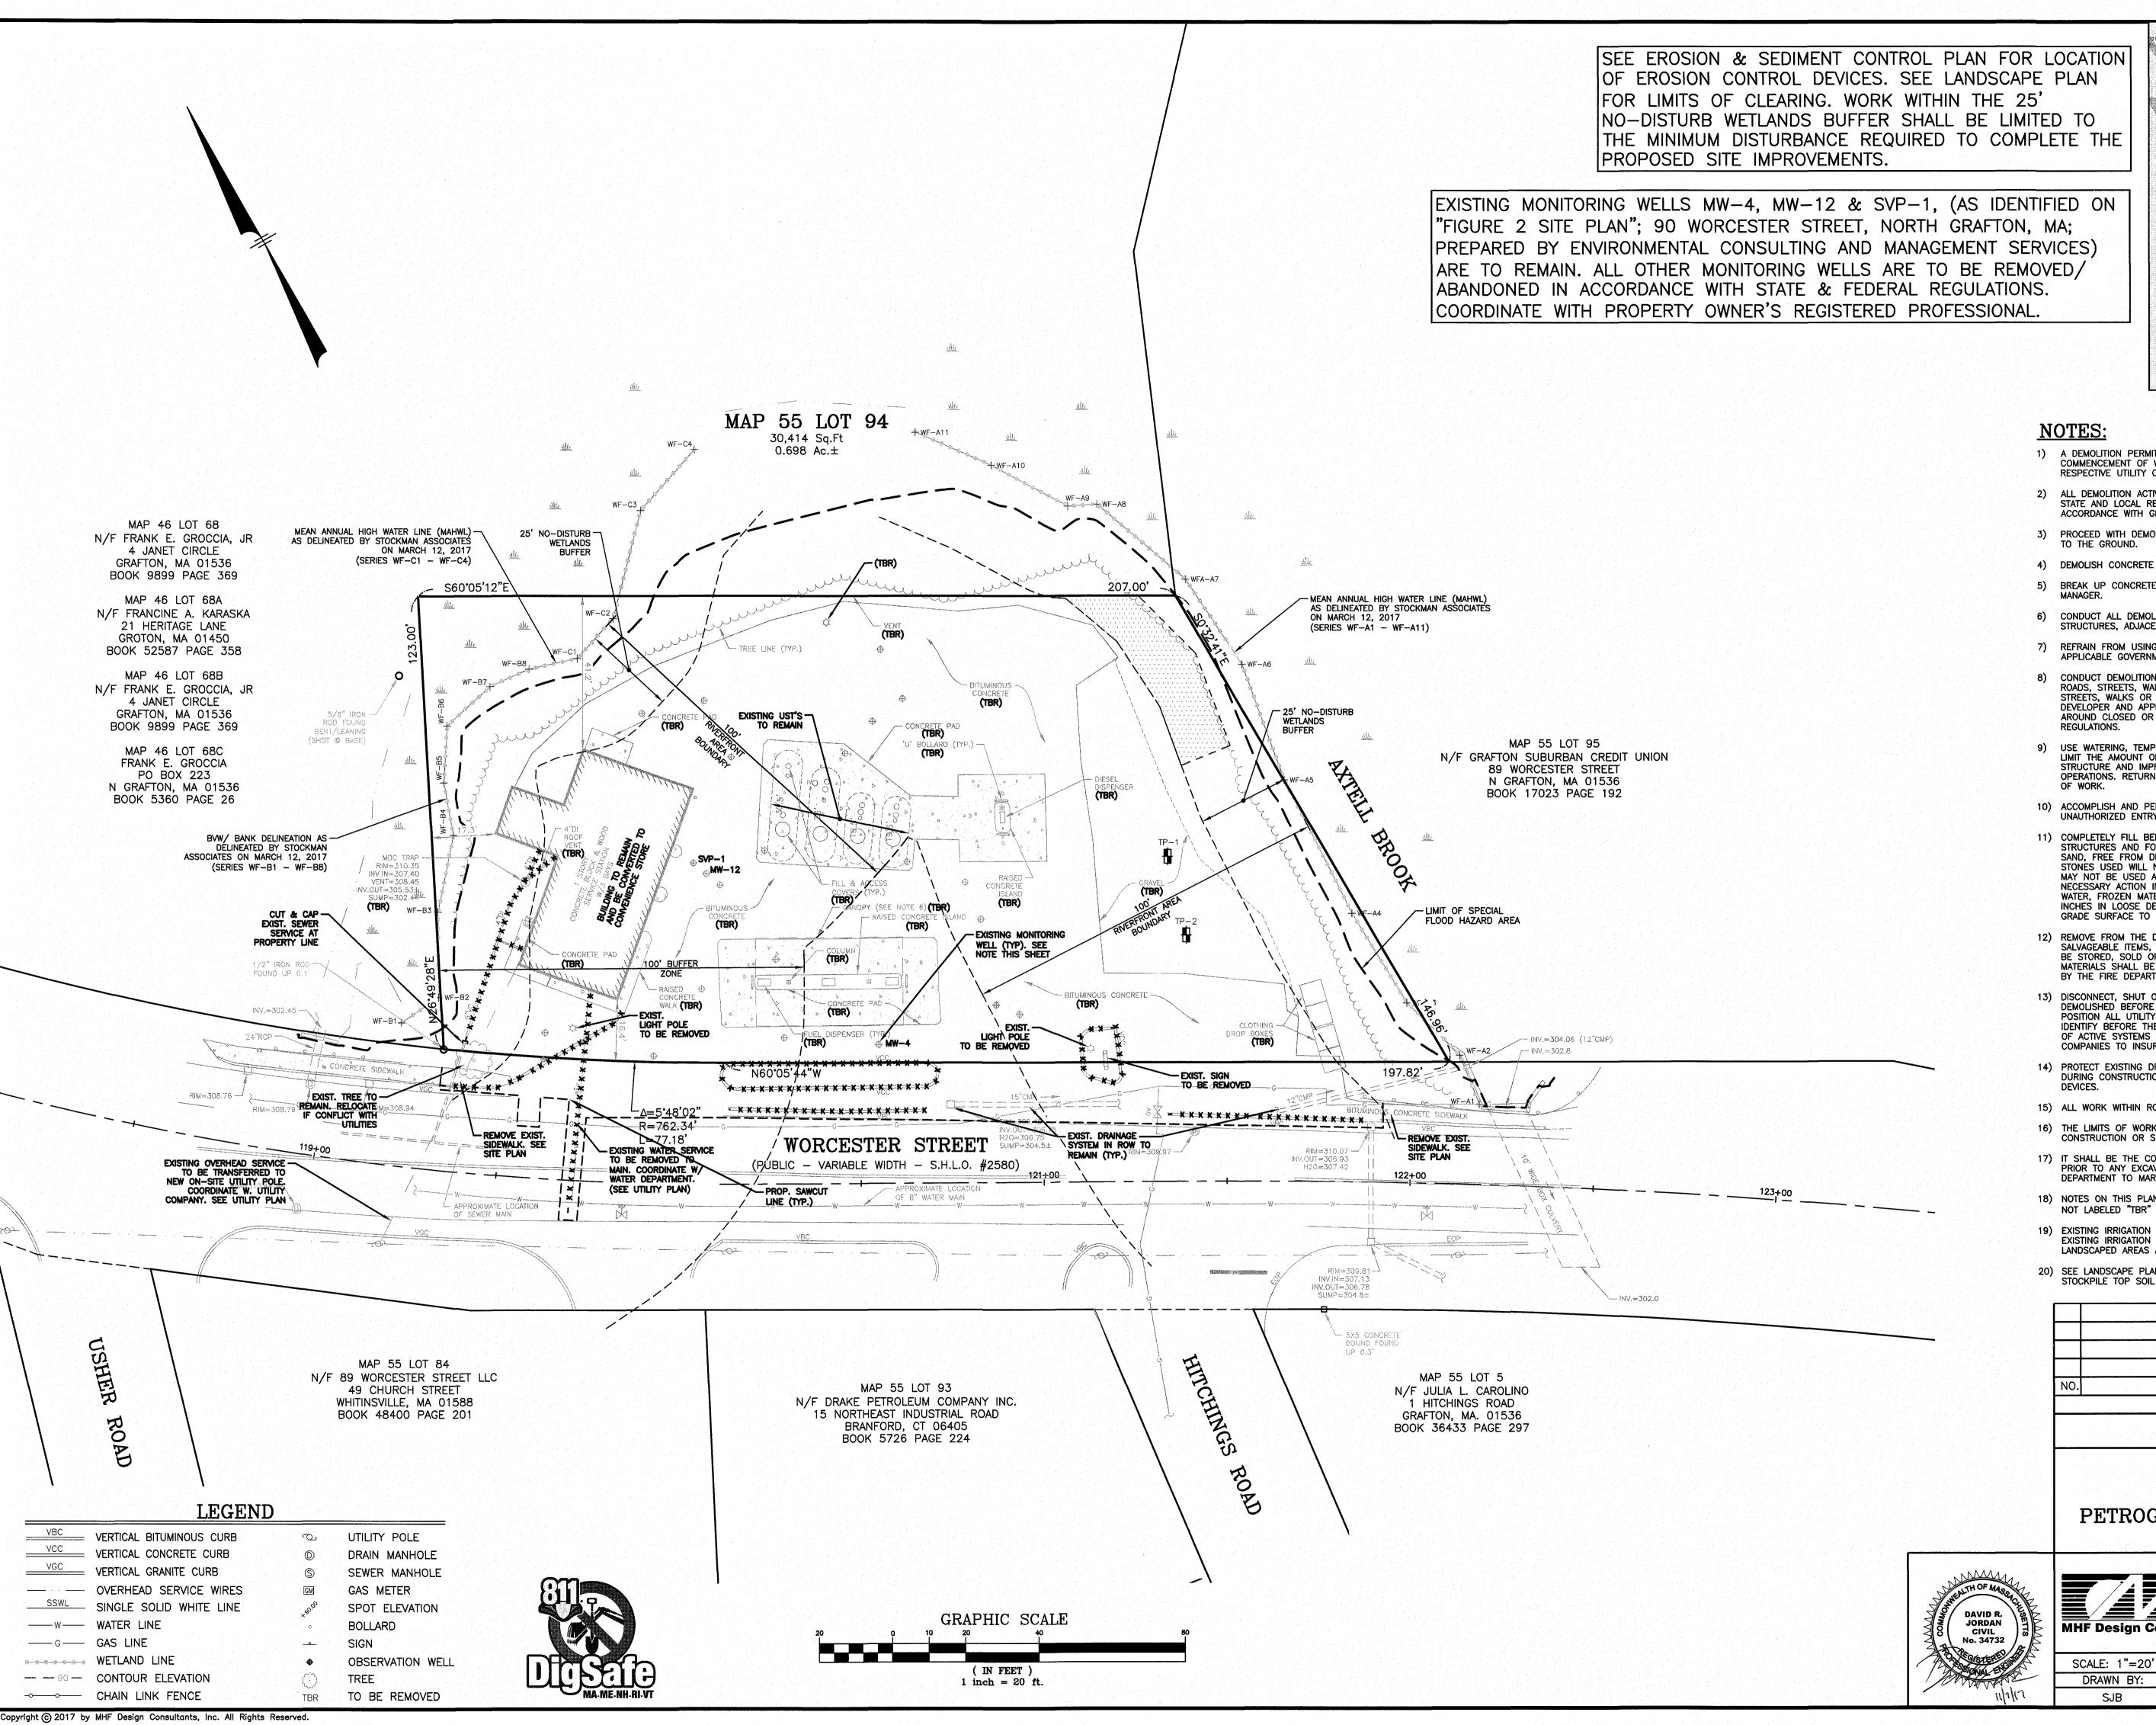
DRAWING NO. 4088TWS.DWG SCALE: 1"=20" DATE: NOVEMEBER 7, 2017 DRAWN BY: CHECKED BY: PROJECT NO. SHEET NO. 408816 2 OF 10 DRJ

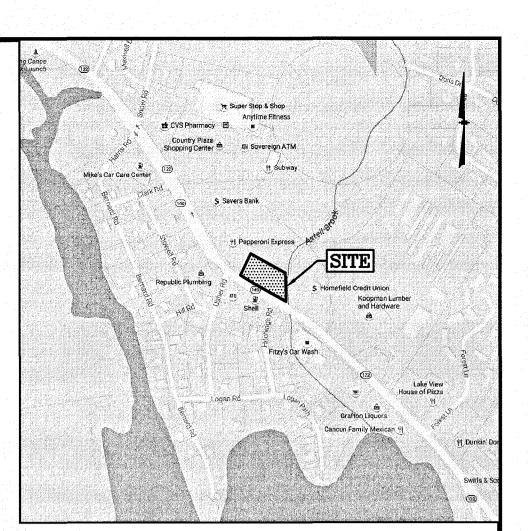
£

TREE

— — 90 — CONTOUR ELEVATION

------ CHAIN LINK FENCE





LOCATION MAP

- 1) A DEMOLITION PERMIT MUST BE OBTAINED FROM THE TOWN OF GRAFTON PRIOR TO COMMENCEMENT OF WORK. ALL EXISTING UTILITY DISCONNECTIONS MUST BE COORDINATED WITH RESPECTIVE UTILITY COMPANIES.
- 2) ALL DEMOLITION ACTIVITIES ARE TO BE PERFORMED IN STRICT ADHERENCE TO ALL FEDERAL, STATE AND LOCAL REGULATIONS. CONTRACTOR TO INSTALL EROSION CONTROL DEVICES IN ACCORDANCE WITH GRADING & DRAINAGE PLAN PRIOR TO BEGINNING DEMOLITION ACTIVITIES.
- 3) PROCEED WITH DEMOLITION IN A SYSTEMATIC MANNER, FROM THE TOP OF THE STRUCTURE(S)
- 4) DEMOLISH CONCRETE IN ALL SECTIONS
- 5) BREAK UP CONCRETE SLABS—ON—GRADE, UNLESS OTHERWISE DIRECTED BY THE CONSTRUCTION
- 6) CONDUCT ALL DEMOLITION OPERATIONS IN A MANNER THAT WILL PREVENT INJURY, DAMAGE TO STRUCTURES, ADJACENT BUILDINGS AND ALL PERSONS.
- 7) REFRAIN FROM USING EXPLOSIVES WITHOUT PRIOR WRITTEN CONSENT OF THE DEVELOPER AND APPLICABLE GOVERNMENTAL AUTHORITIES.
- 8) CONDUCT DEMOLITION SERVICES IN SUCH A MANNER TO INSURE MINIMUM INTERFERENCE WITH ROADS, STREETS, WALKS AND OTHER ADJACENT FACILITIES. DO NOT CLOSE OR OBSTRUCT STREETS, WALKS OR OTHER OCCUPIED FACILITIES WITHOUT PRIOR WRITTEN PERMISSION OF THE DEVELOPER AND APPLICABLE GOVERNMENTAL AUTHORITIES. PROVIDE ALTERNATIVE ROUTES AROUND CLOSED OR OBSTRUCTED TRAFFIC WAYS IF REQUIRED BY APPLICABLE GOVERNMENTAL
- 9) USE WATERING, TEMPORARY ENCLOSURES AND OTHER SUITABLE METHODS, AS NECESSARY TO LIMIT THE AMOUNT OF DUST AND DIRT RISING AND SCATTERING IN THE AIR. CLEAN ADJACENT STRUCTURE AND IMPROVEMENTS OF ALL DUST AND DEBRIS CAUSED BY THE DEMOLITION OPERATIONS. RETURN ALL ADJACENT AREAS TO THE CONDITIONS EXISTING PRIOR TO THE START
- 10) ACCOMPLISH AND PERFORM THE DEMOLITION IN SUCH A MANNER AS TO PREVENT THE UNAUTHORIZED ENTRY OF PERSONS AT ANY TIME.
- 11) COMPLETELY FILL BELOW GRADE AREAS AND VOIDS RESULTING FROM THE DEMOLITION OF STRUCTURES AND FOUNDATIONS WITH SOIL MATERIALS CONSISTING OF STONE, GRAVEL AND SAND, FREE FROM DEBRIS, TRASH, FROZEN MATERIALS, ROOTS AND OTHER ORGANIC MATTER. STONES USED WILL NOT BE LARGER THAT 6 INCHES IN DIMENSION. MATERIAL FROM DEMOLITION MAY NOT BE USED AS FILL. PRIOR TO PLACEMENT OF FILL MATERIALS, UNDERTAKE ALL NECESSARY ACTION IN ORDER TO INSURE THAT AREAS TO BE FILLED ARE FREE OF STANDING WATER, FROZEN MATERIAL, TRASH, DEBRIS. PLACE FILL MATERIALS LAYERS NOT EXCEEDING 6 INCHES IN LOOSE DEPTH AND COMPACT EACH LAYER AT PLACEMENT TO 95% OPTIMUM DENSITY, GRADE SURFACE TO MEET ADJACENT CONTOURS AND TO PROVIDE SURFACE DRAINAGE.
- 12) REMOVE FROM THE DESIGNATED SITE, AT THE EARLIEST POSSIBLE TIME, ALL DEBRIS RUBBISH SALVAGEABLE ITEMS. HAZARDOUS AND COMBUSTIBLE SERVICES, REMOVED MATERIALS MAY NOT BE STORED, SOLD OR BURNED ON SITE. REMOVAL OF HAZARDOUS AND COMBUSTIBLE MATERIALS SHALL BE ACCOMPLISHED IN ACCORDANCE WITH THE PROCEDURES AS AUTHORIZED BY THE FIRE DEPARTMENT OR OTHER APPROPRIATE REGULATORY AGENCIES AND DEPARTMENTS.
- 13) DISCONNECT, SHUT OFF AND SEAL ALL UTILITIES SERVING THE STRUCTURE(S) TO BE DEMOLISHED BEFORE THE COMMENCEMENT OF THE DESIGNATED DEMOLITION. MARK FOR POSITION ALL UTILITY DRAINAGE AND SANITARY LINES AND PROTECT ALL ACTIVE LINES. CLEARLY IDENTIFY BEFORE THE COMMENCEMENT OF DEMOLITION SERVICES THE REQUIRED INTERRUPTION OF ACTIVE SYSTEMS THAT MAY AFFECT OTHER PARTIES, AND NOTIFY ALL APPLICABLE UTILITY COMPANIES TO INSURE THE CONTINUATION OF SERVICE.
- 14) PROTECT EXISTING DRAINAGE SYSTEM(S) AS NECESSARY TO PREVENT SEDIMENT FROM ENTERING DURING CONSTRUCTION. SEE EROSION & SEDIMENT CONTROL PLAN FOR EROSION CONTROL
- 15) ALL WORK WITHIN ROADWAY RIGHT-OF-WAYS TO CONFORM TO MASS DOT STANDARDS.
- 16) THE LIMITS OF WORK SHALL BE CLEARLY MARKED IN THE FIELD PRIOR TO THE START OF CONSTRUCTION OR SITE CLEARING.
- 17) IT SHALL BE THE CONTRACTORS RESPONSIBILITY TO NOTIFY DIG SAFE (DIAL 811) 72 HOURS PRIOR TO ANY EXCAVATION ON THIS SITE. CONTRACTOR SHALL ALSO NOTIFY LOCAL WATER DEPARTMENT TO MARK OUT THEIR UTILITIES.
- 18) NOTES ON THIS PLAN THAT READ "TBR" REPRESENT FEATURES TO BE REMOVED. ANY FEATURES NOT LABELED "TBR" OR "TO BE REMOVED" SHALL BE CONSIDERED EXISTING TO REMAIN.
- 19) EXISTING IRRIGATION SYSTEM TO BE PROTECTED DURING DEMOLITION AND CONSTRUCTION. EXISTING IRRIGATION SYSTEM TO BE RELOCATED, EXTENDED AND CONNECTED TO ALL PROPOSED LANDSCAPED AREAS AS NECESSARY.
- 20) SEE LANDSCAPE PLAN FOR LIMITS OF CLEARING AND GRUBBING. AFTER CLEARING, STRIP AND STOCKPILE TOP SOIL PER LANDSCAPE PLAN, IF APPLICABLE.

| NO. | DESCRIPTION | BY | DATE |
|-----|-------------|----|------|
| | REVISIONS | | ' |

DEMOLITION PLAN

ASSESSORS MAP 55 LOT 94 88 WORCESTER STREET GRAFTON, MASSACHUSETTS PREPARED FOR:

PETROGAS GROUP NEW ENGLAND, INC. 168 NORTH MAIN STREET ANDOVER, MASSACHUSETTS 01810

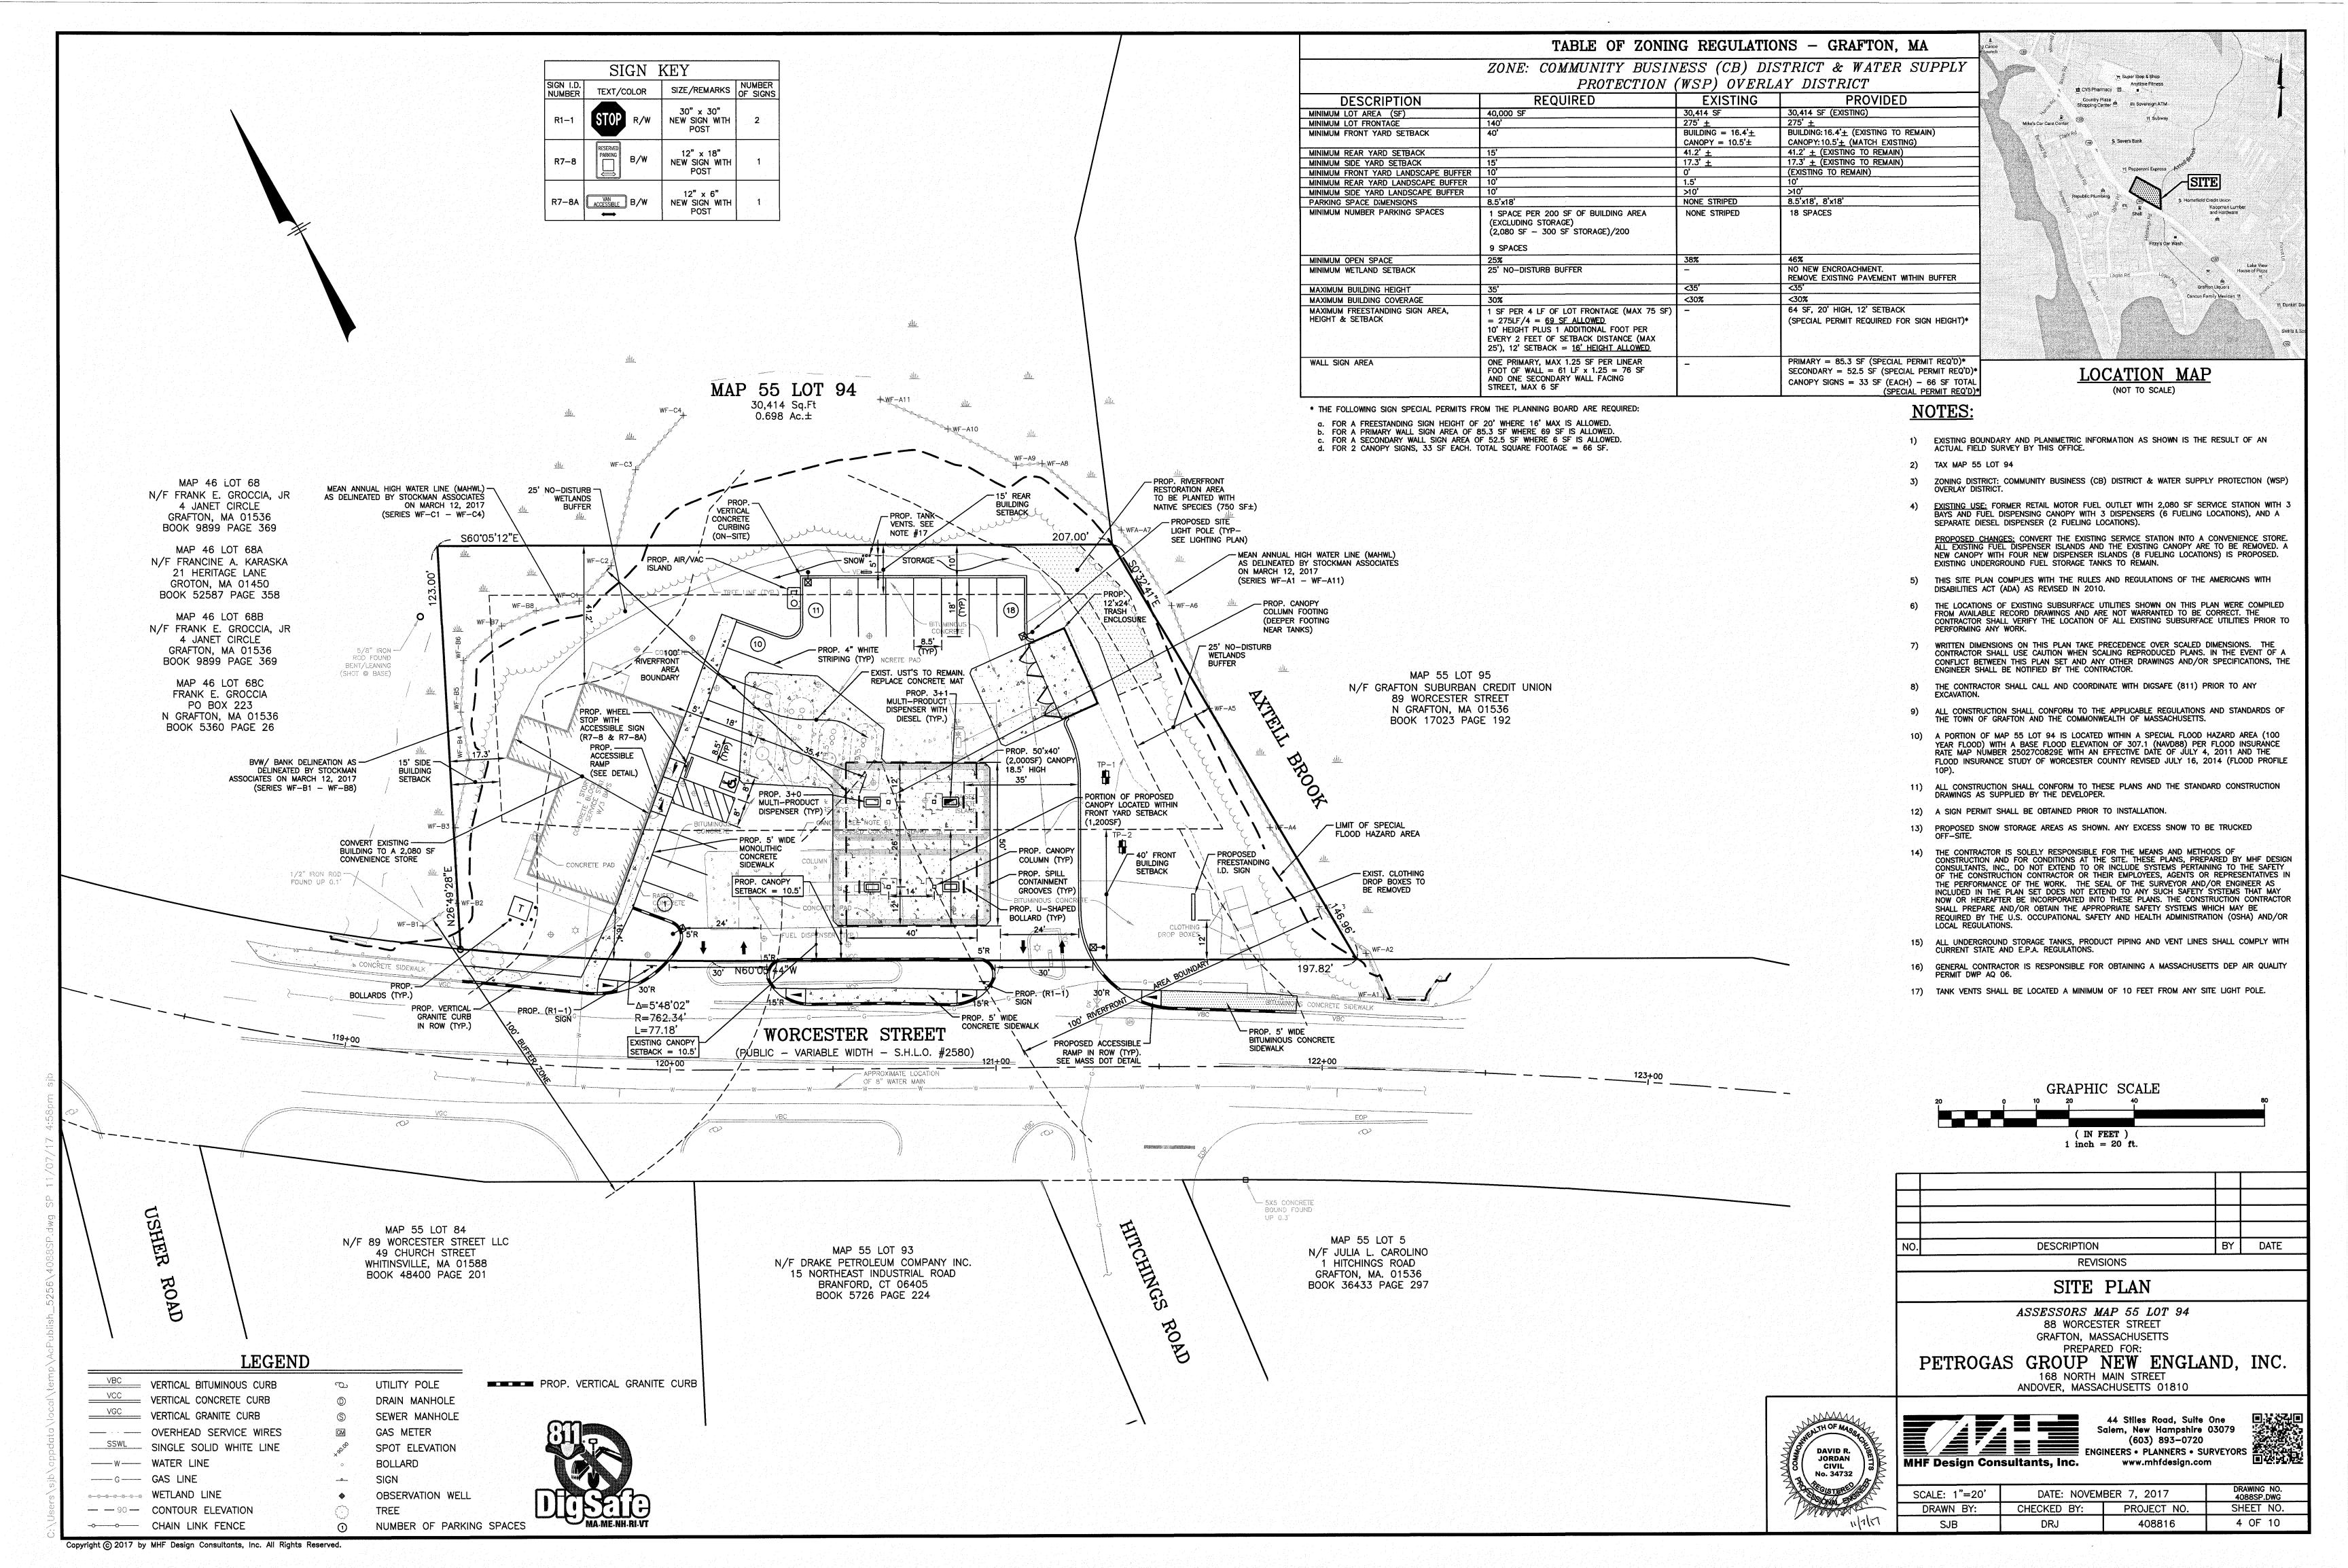


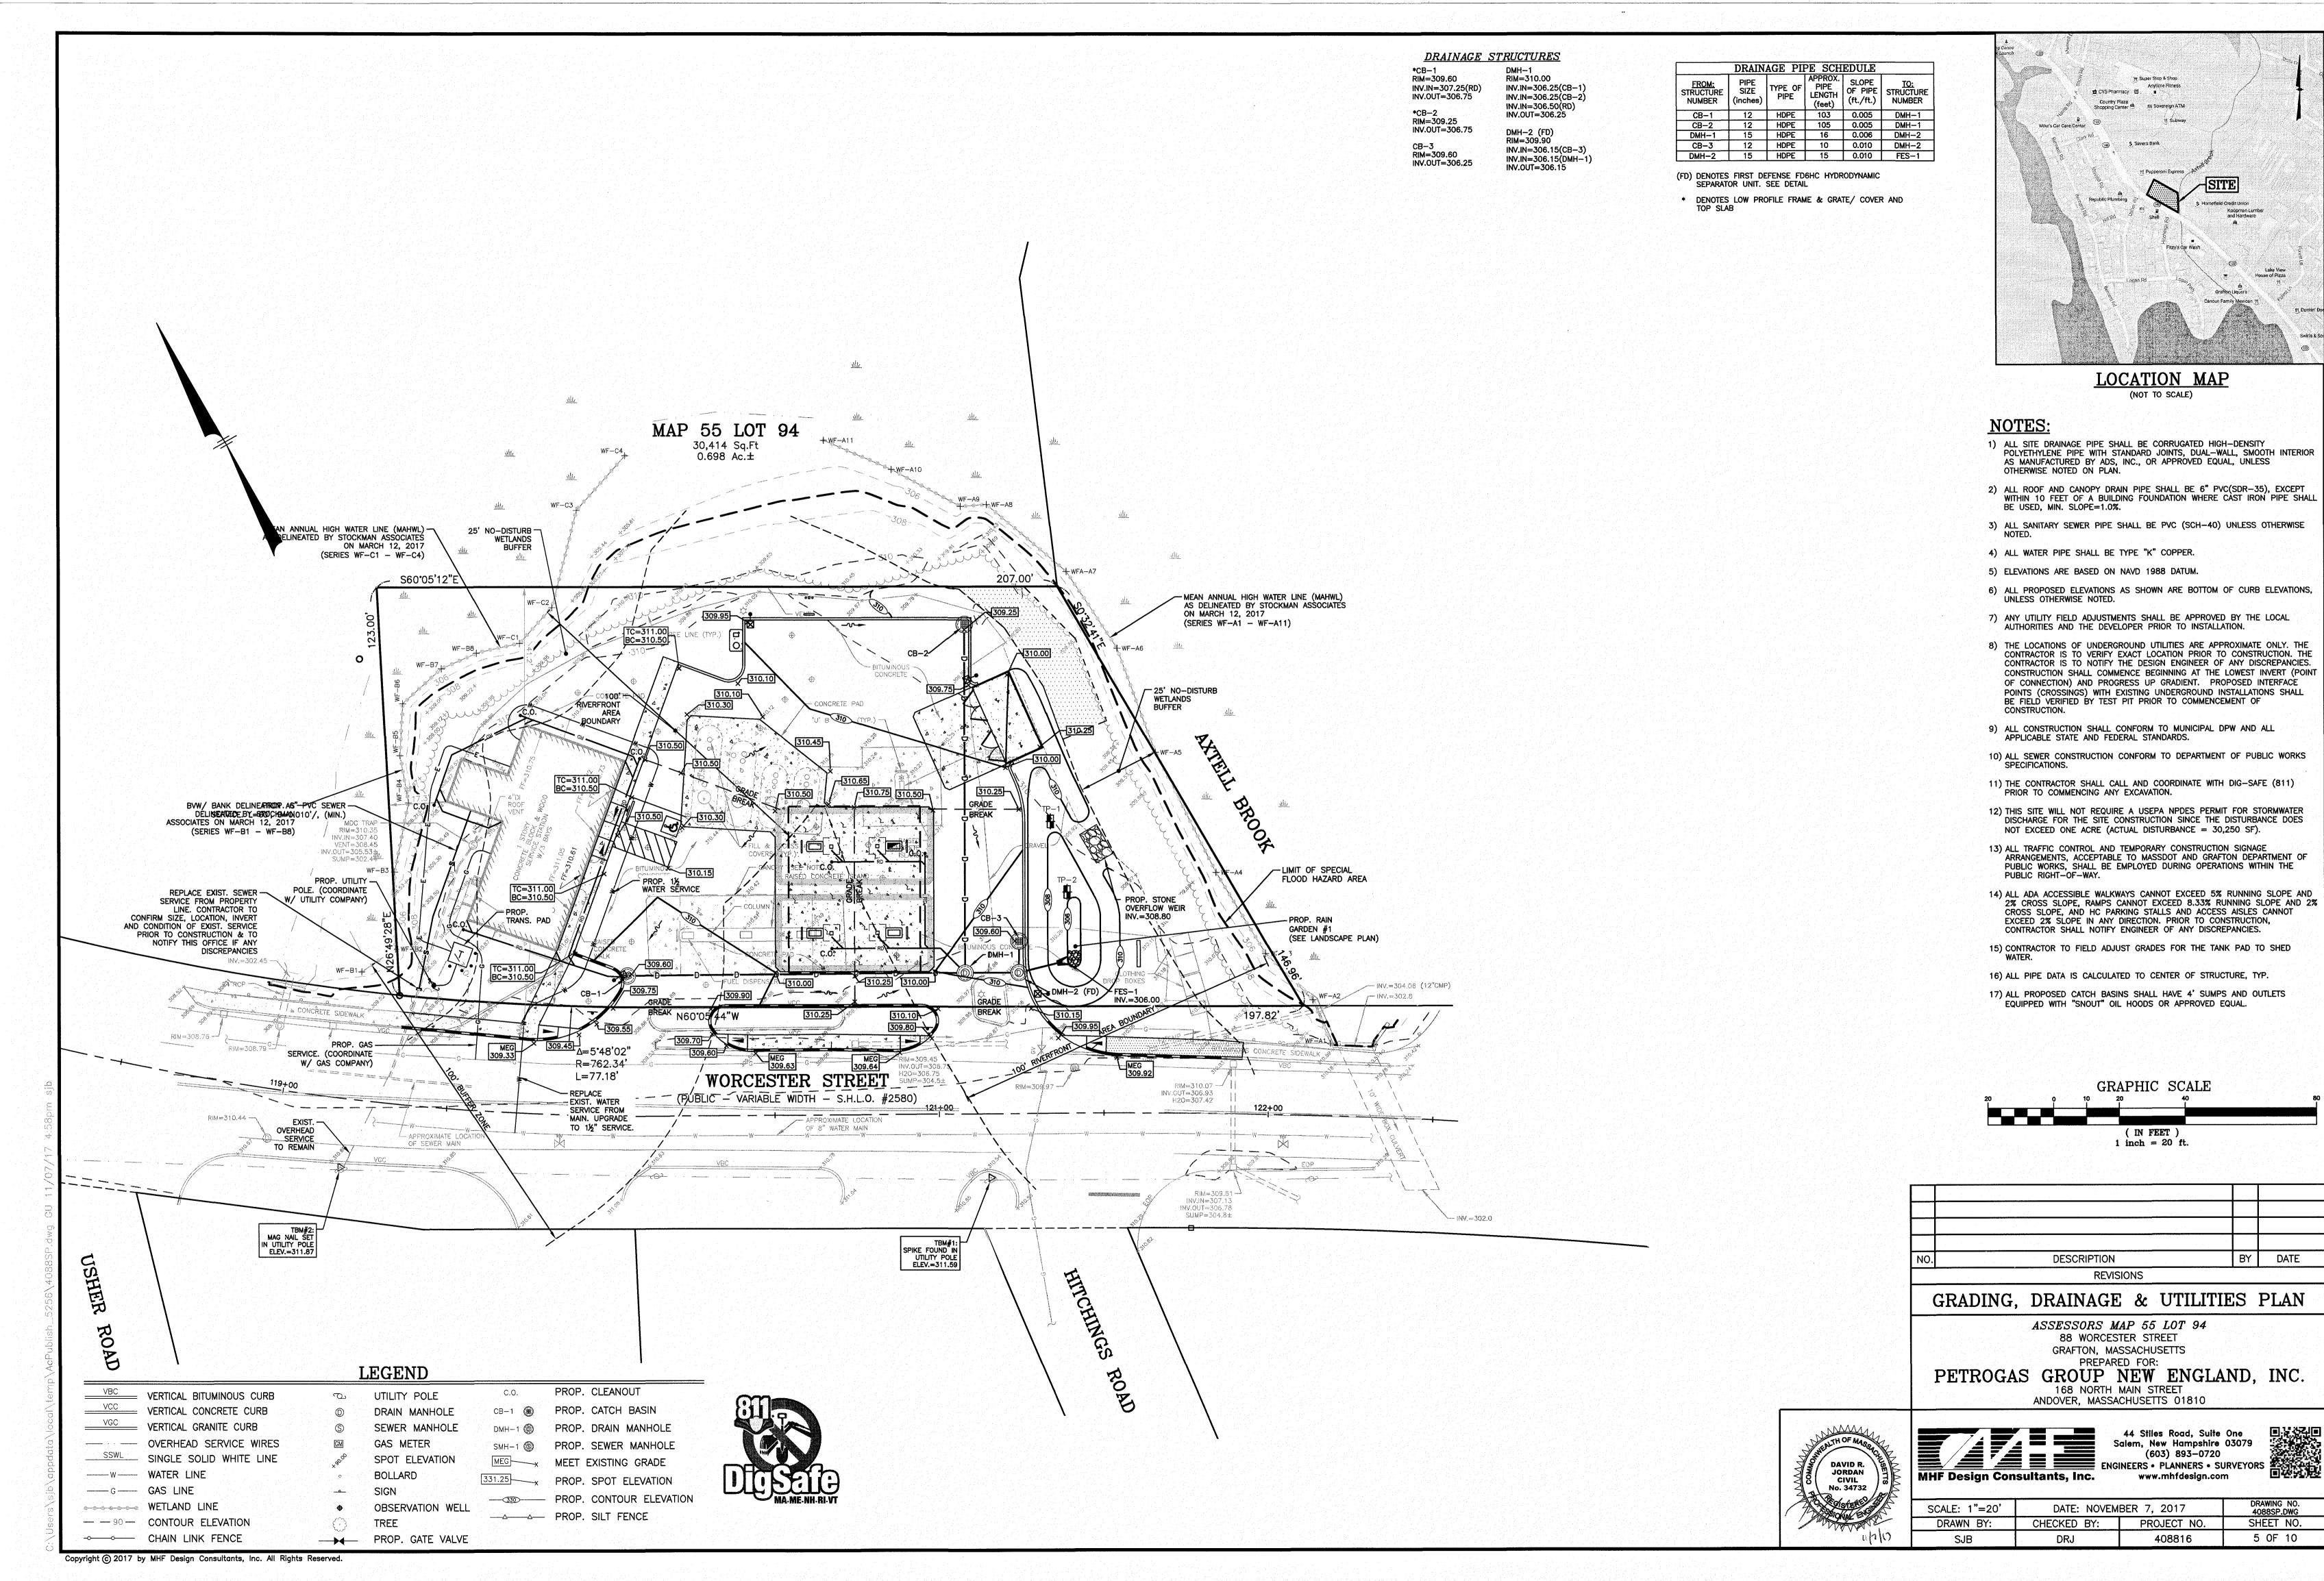


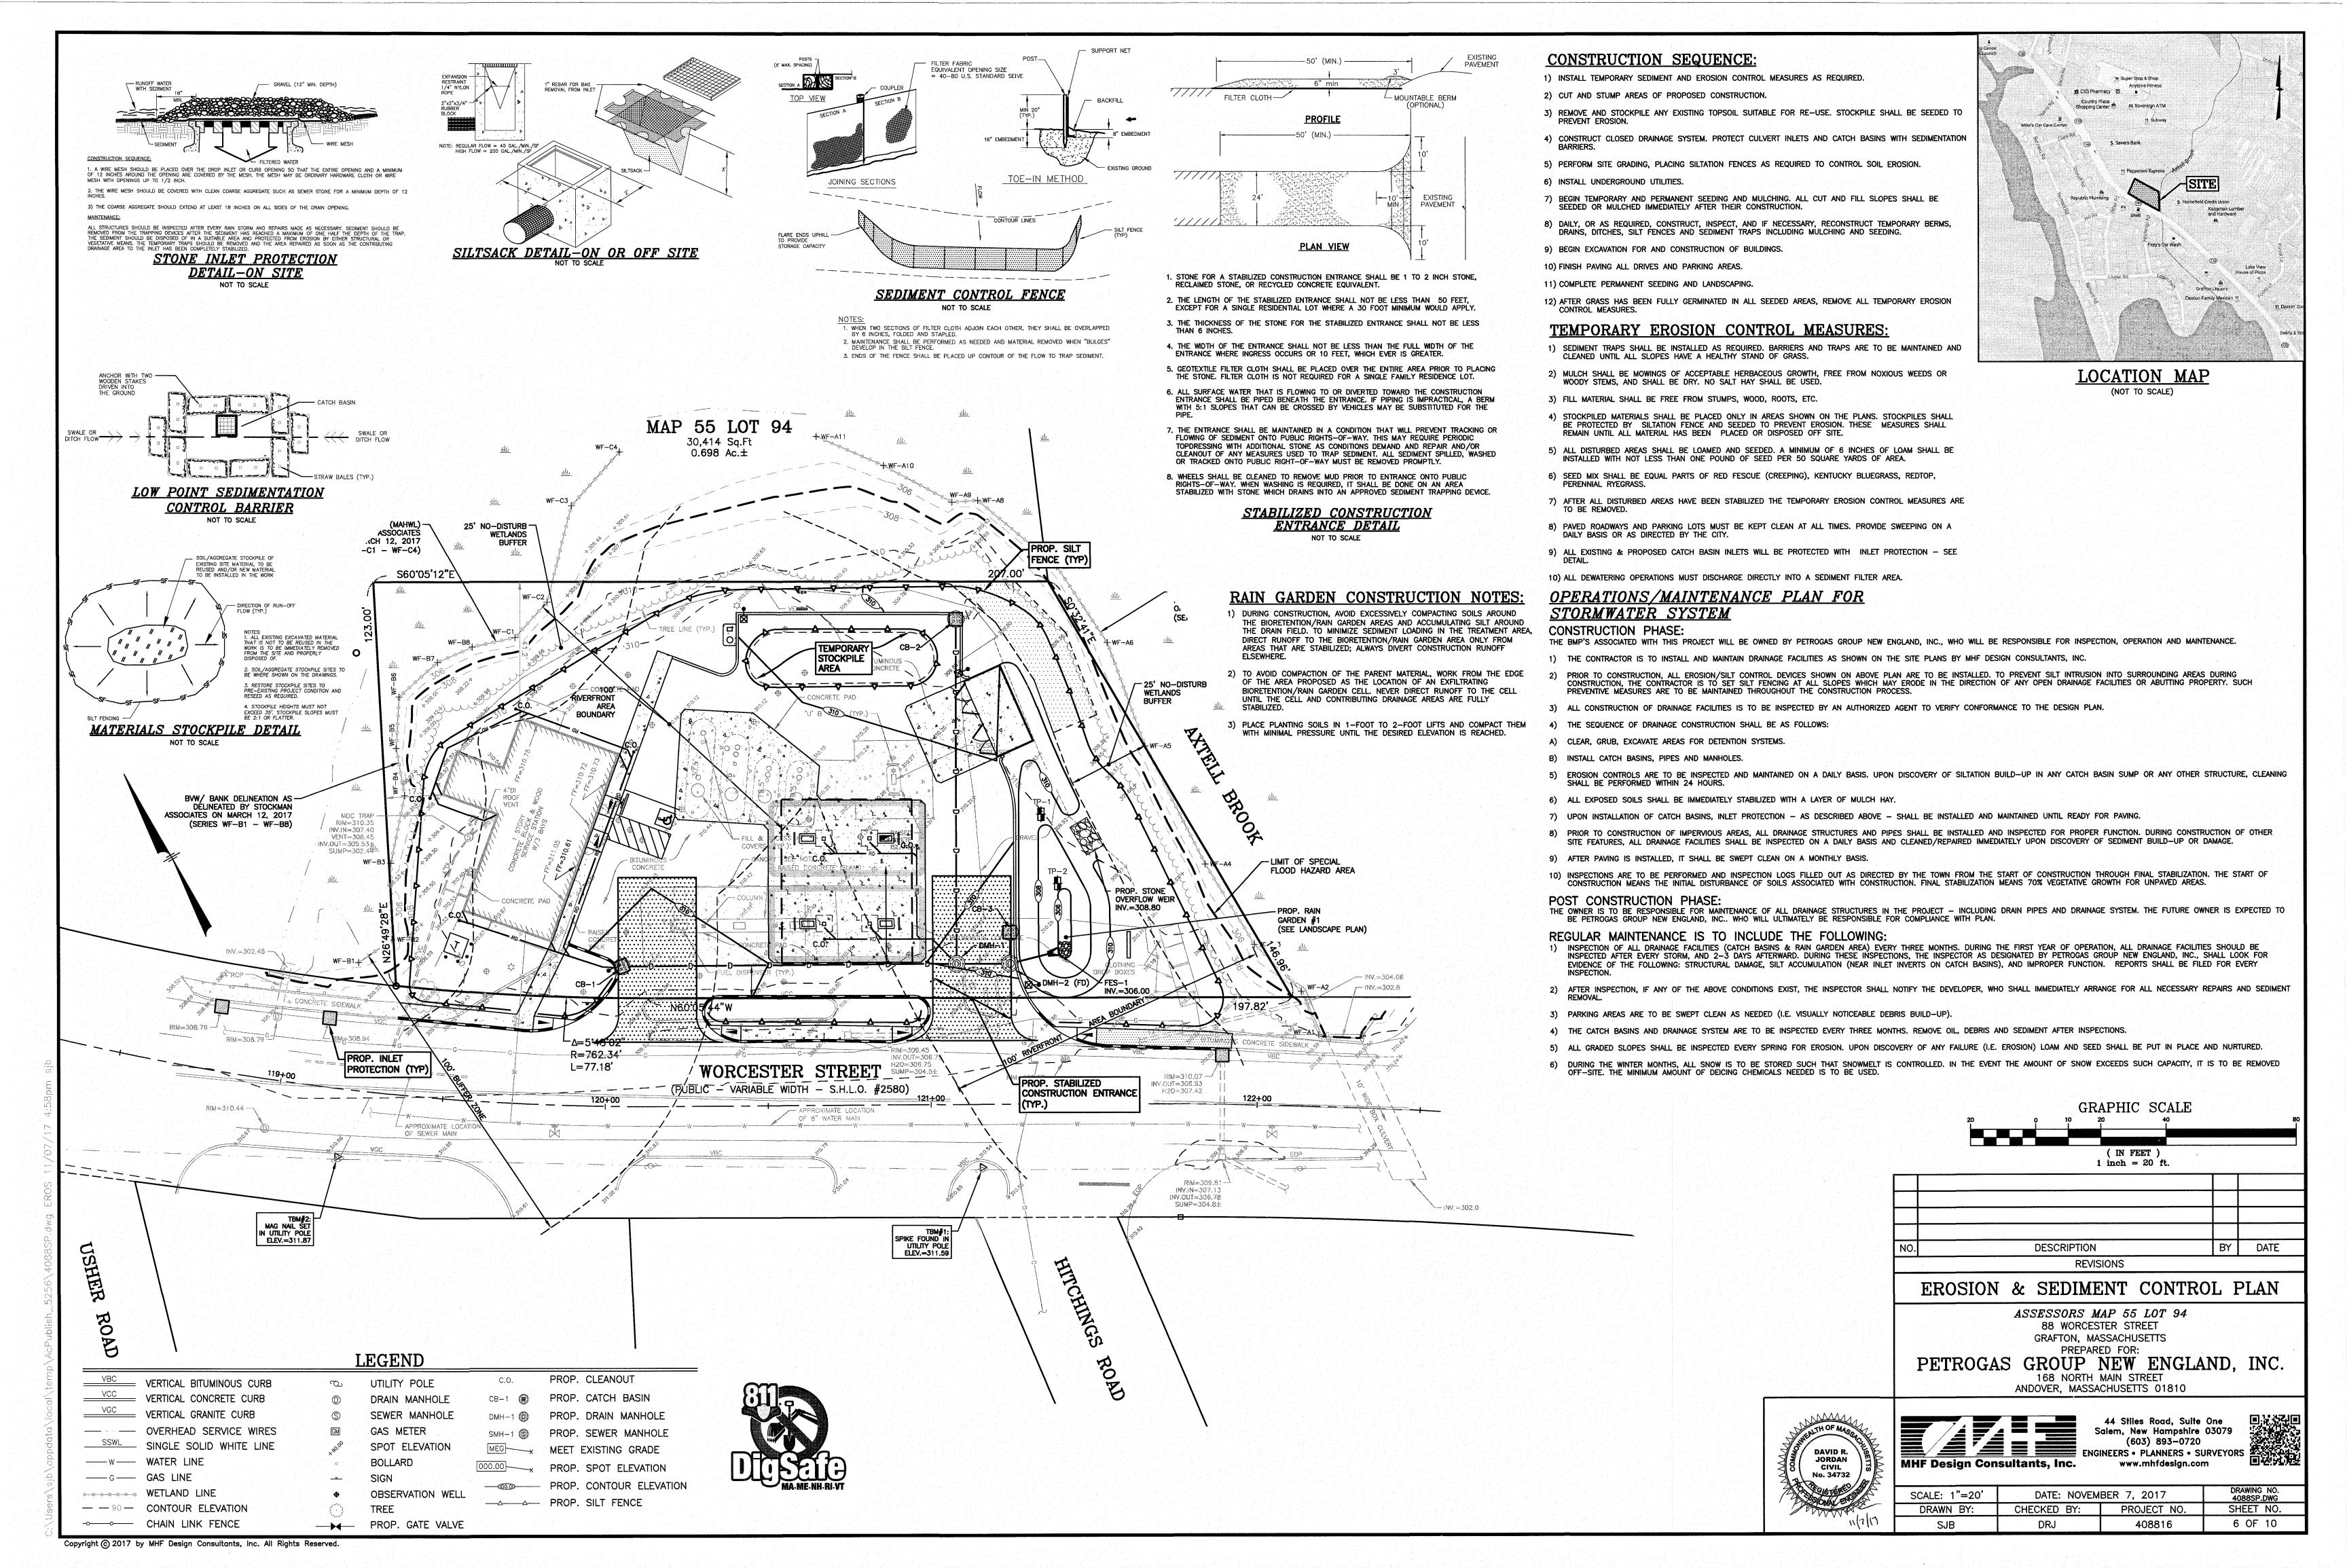
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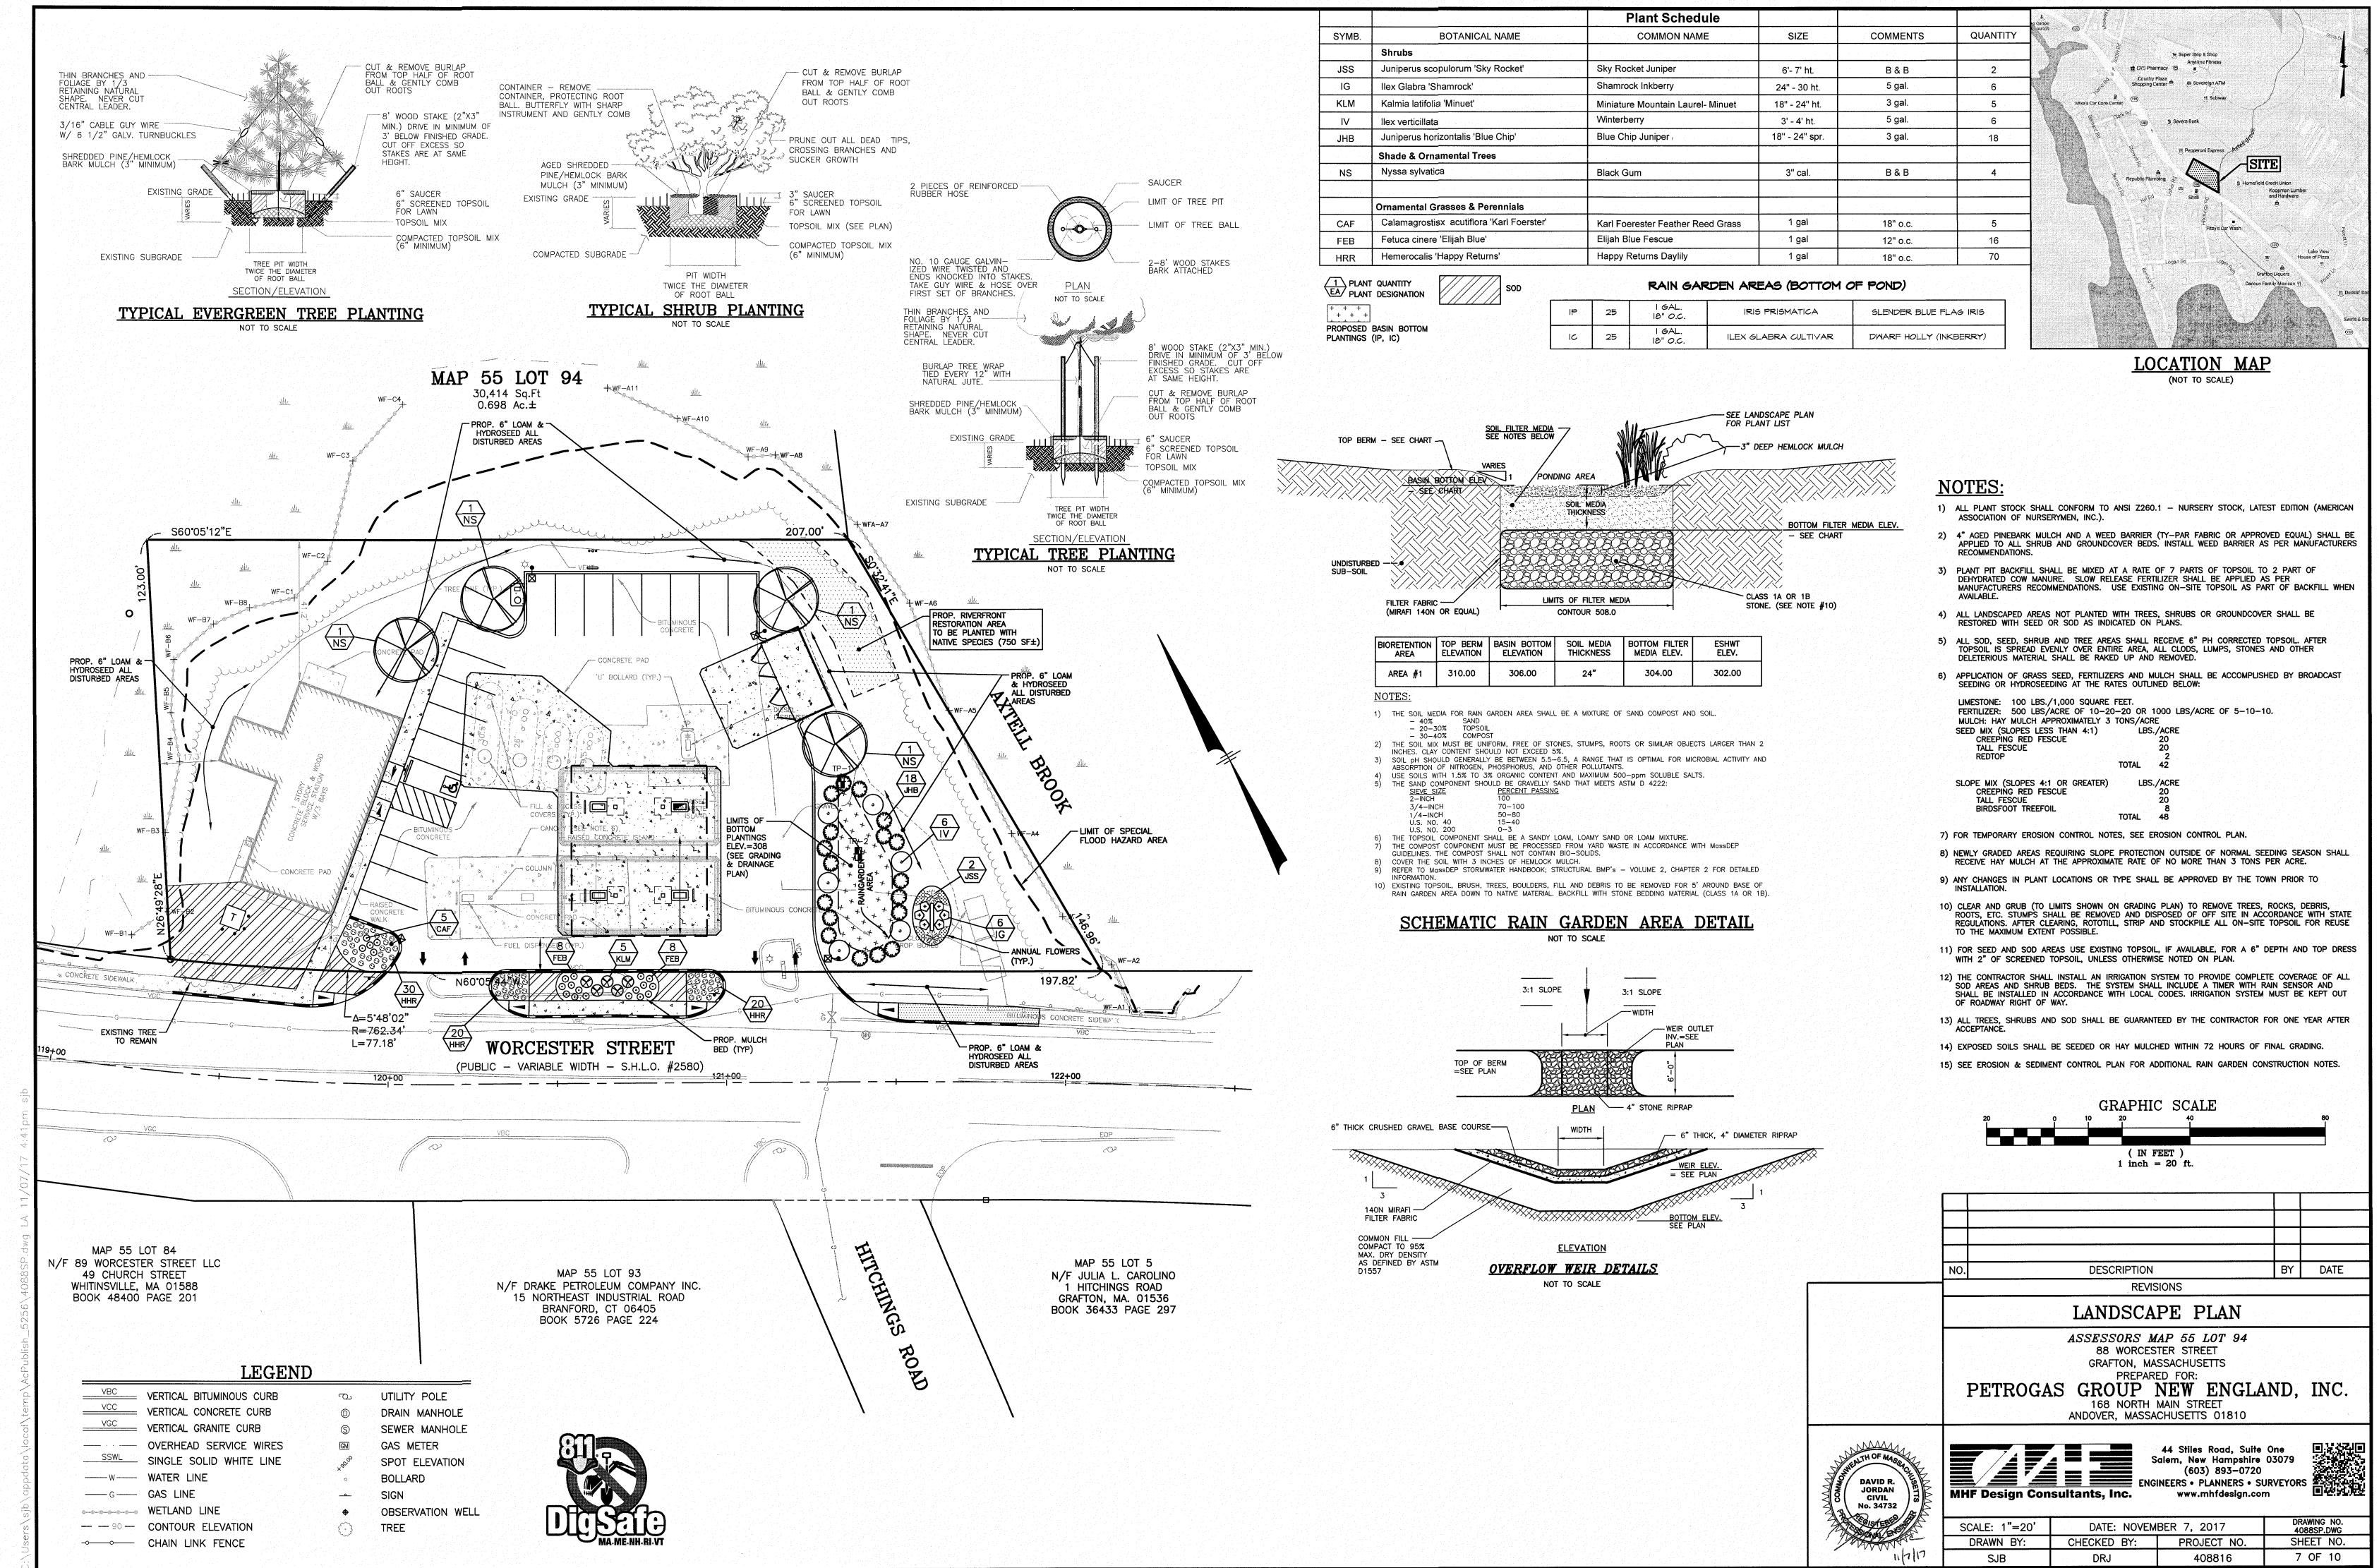


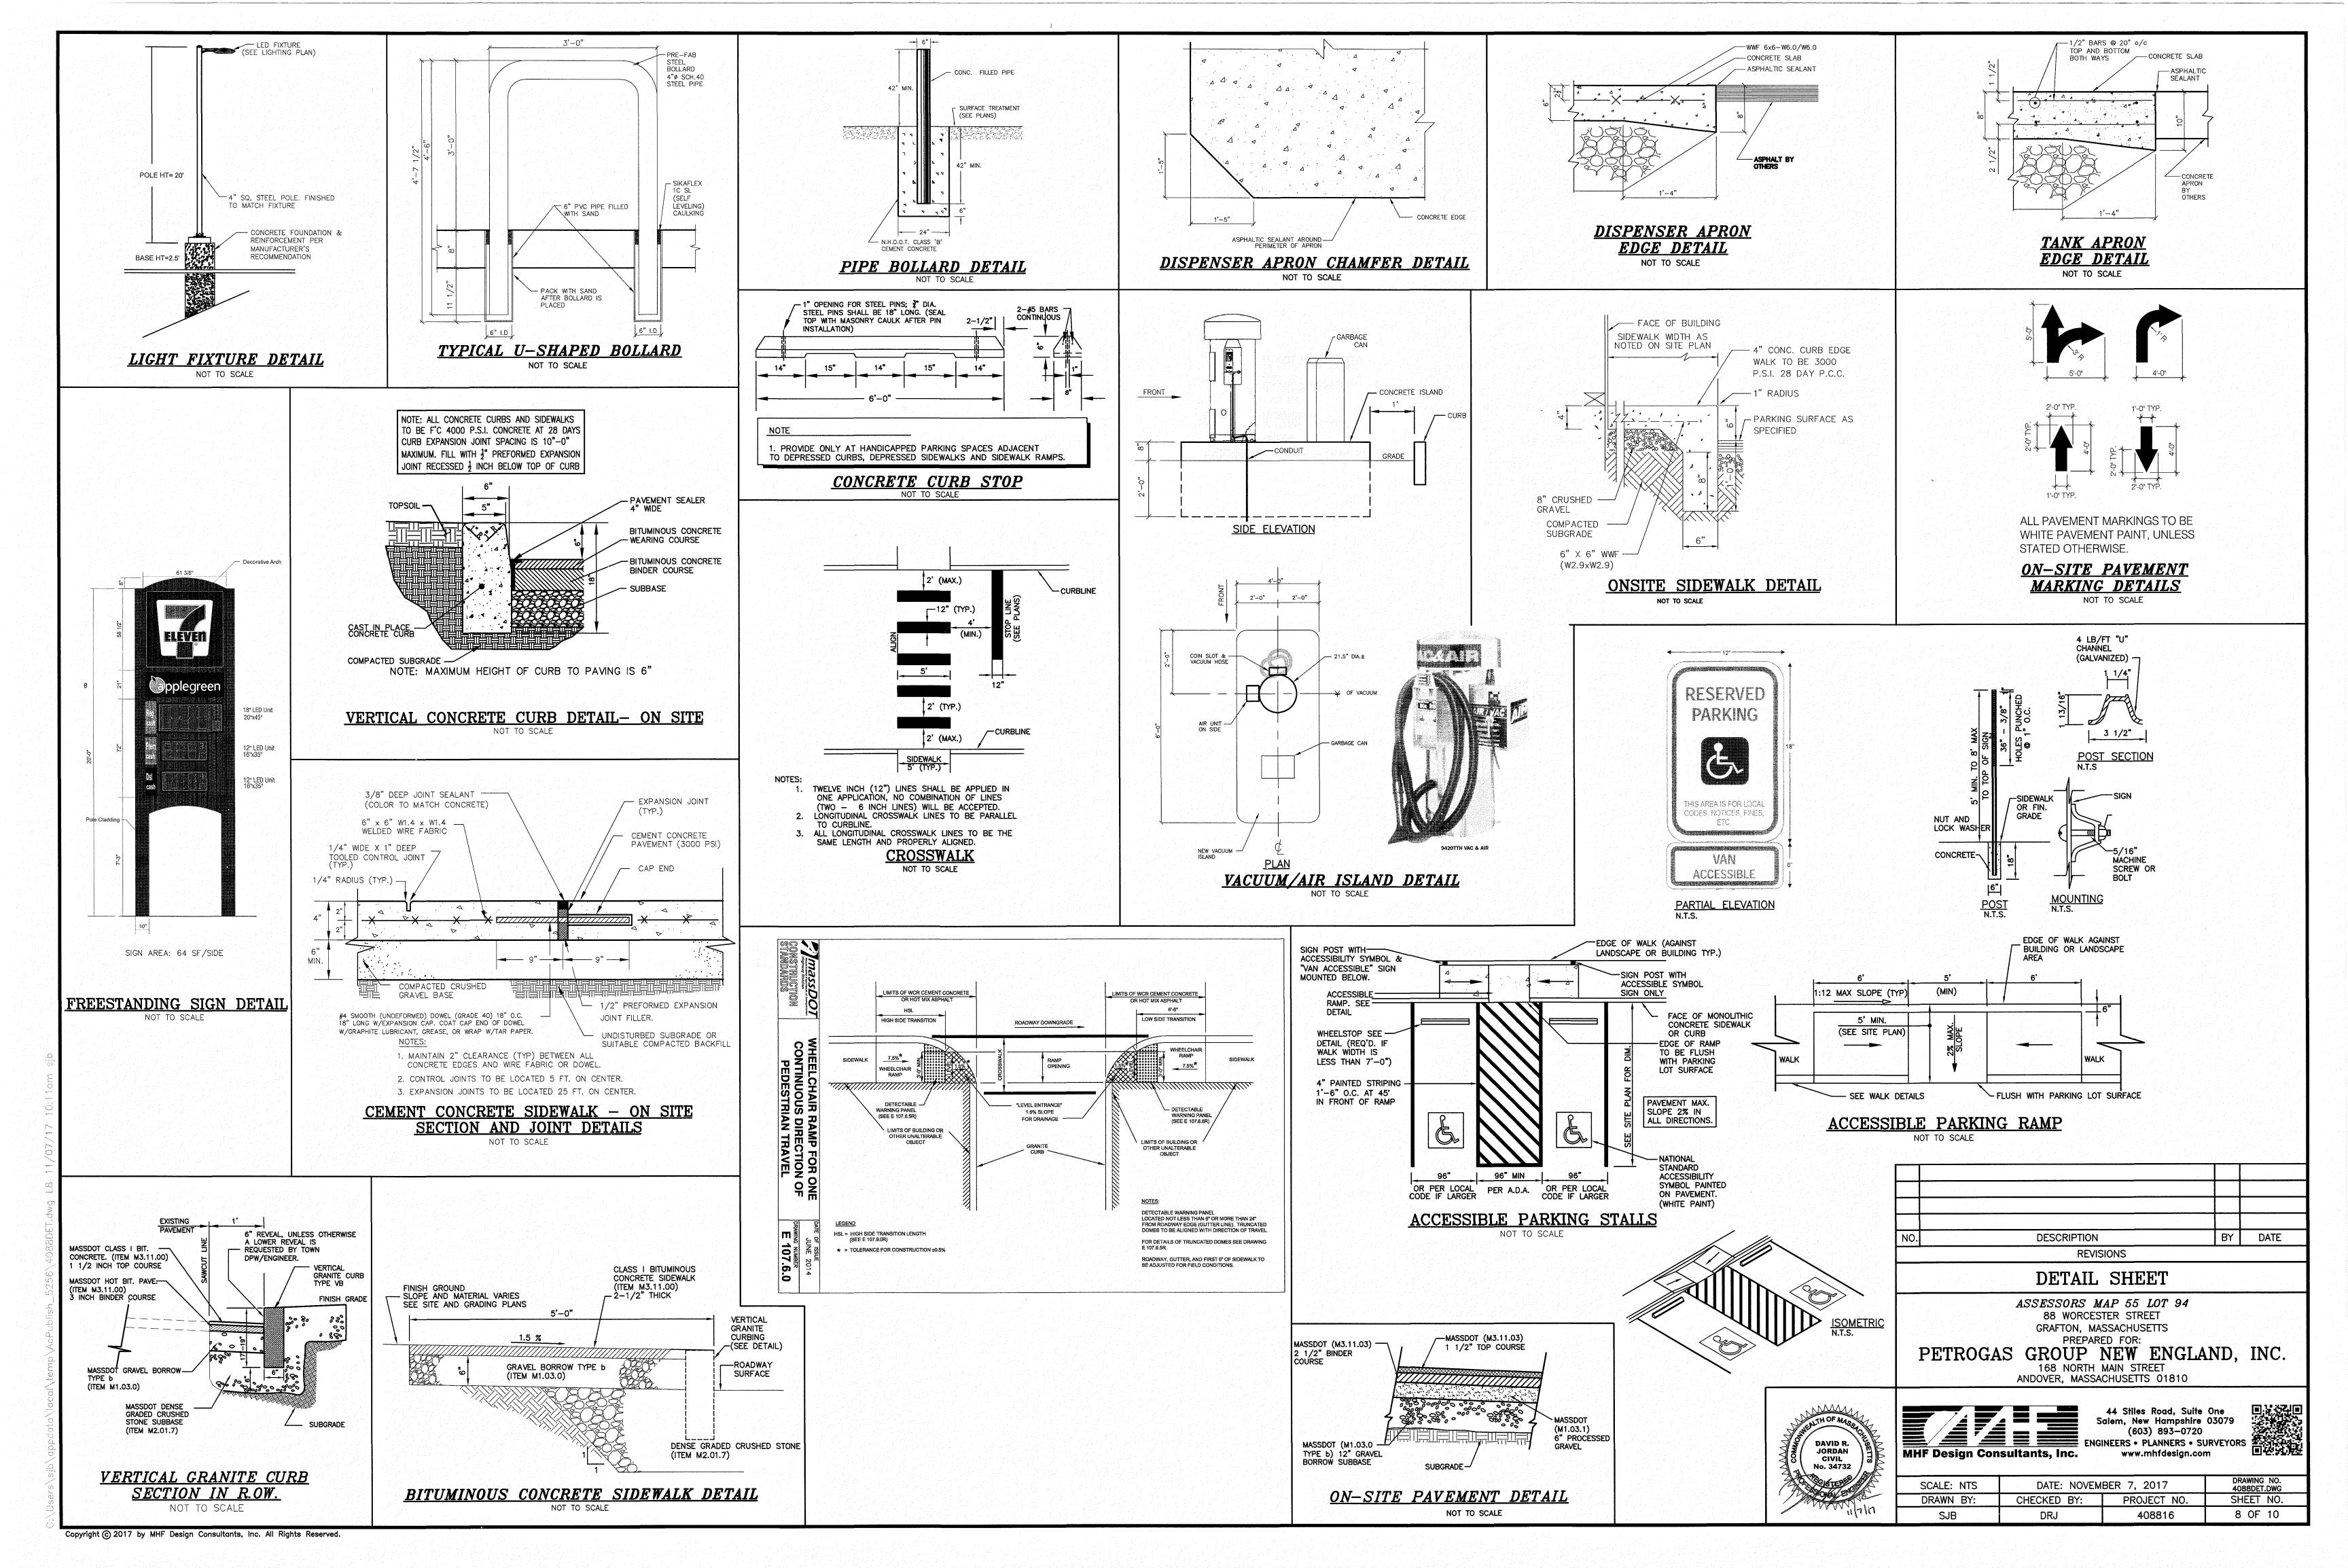
DRAWN BY: SHEET NO. CHECKED BY: PROJECT NO. 3 OF 10 SJB 408816

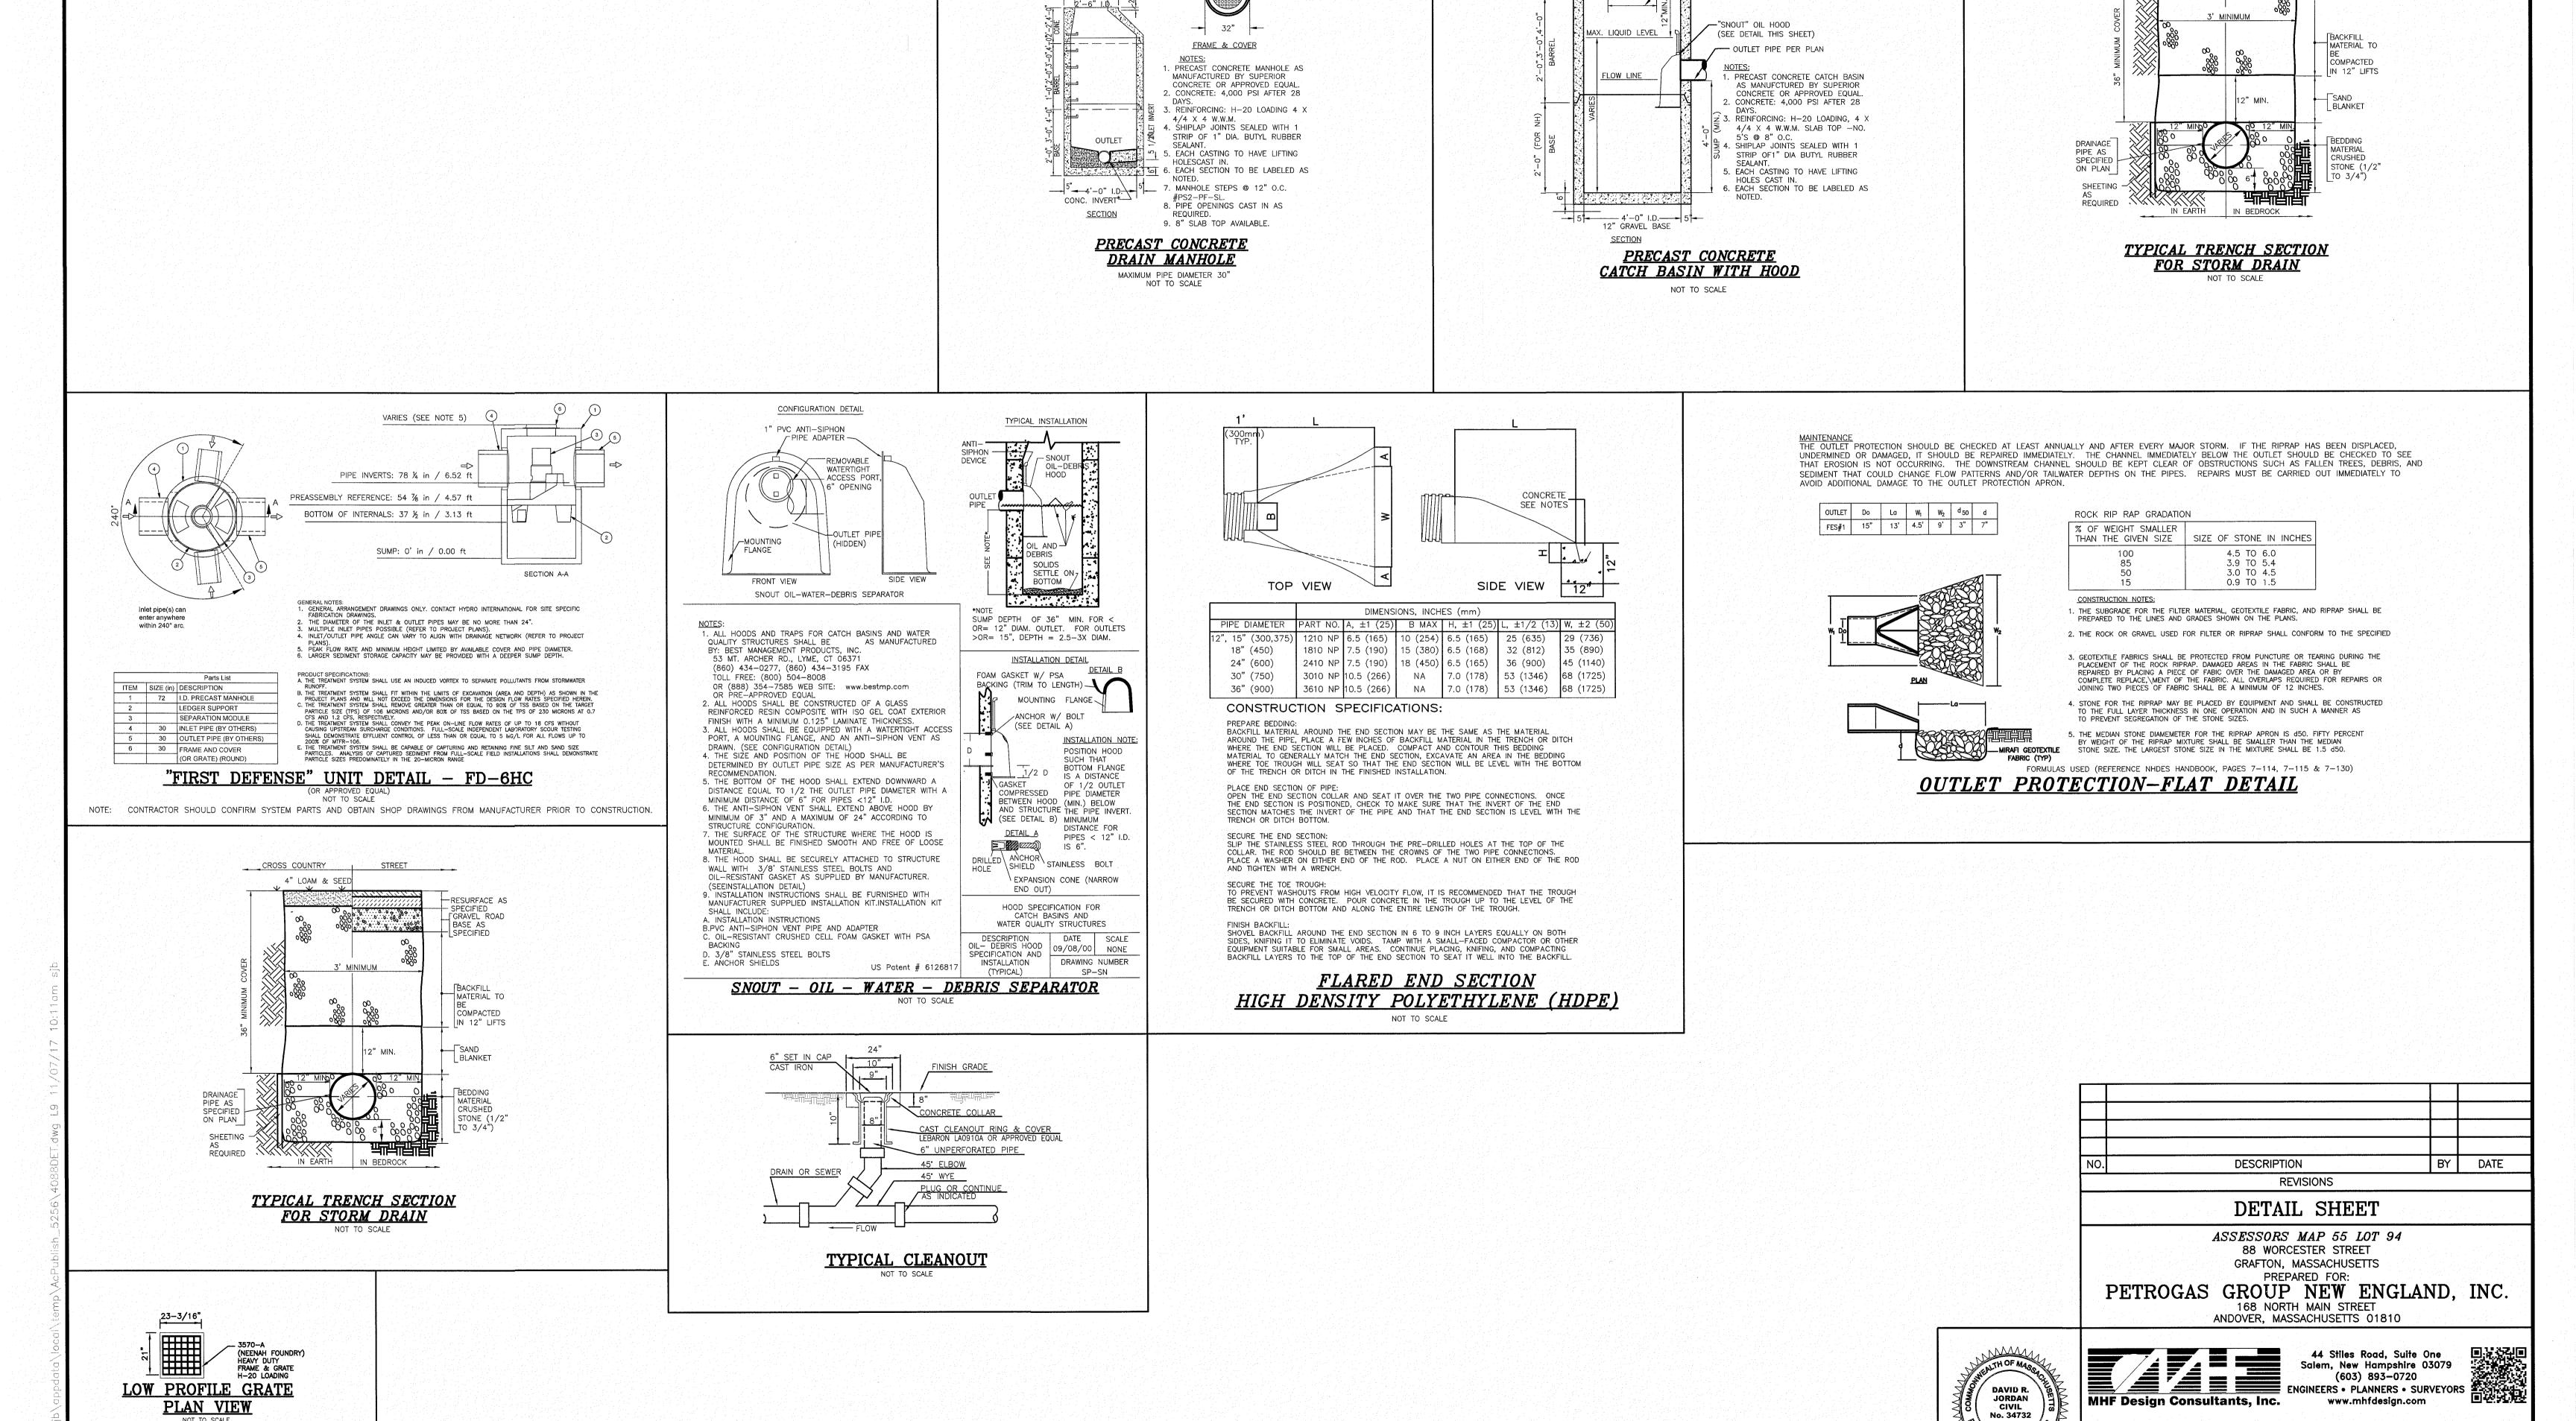












- CEMENT CONC. INVERT

8" (SEE DETAIL)

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BRICKS MAY BE USED -

FOR GRADE ADJUSTMENTS FRAME TO BE SET IN

AMERICAN FOUNDARY -

24"x24" HEAVY DUTY

- 8" TOP SLAB WITH

--- 24" FOR SINGLE FRAME & GRATE 36"×48" FOR DOUBLE

FRAME & GRATE

H-20 LOADING

CROSS COUNTRY STREET

-RESURFACE AS

- SPECIFIED __GRAVEL ROAD

> DRAWING NO. 4088DET.DWG

SHEET NO. 9 OF 10

DATE: NOVEMBER 7, 2017

PROJECT NO.

408816

CHECKED BY:

DRJ

SCALE: NTS
DRAWN BY:

SJB

4" LOAM & SEED

FORM 11 - SOIL EVALUATOR FORM Location Address or Lot No. <u>88 Worcester Street, Grafton, MA</u> On-site Review Deep Hole Number: TP-1 Date: 8/10/17 Time: AM Weather: Sunny 80s Location (identify on site plan) Land Use Commercial Slope (%) 0-5% Surface Stones None Vegetation Landscaping Landform Position on landscape (sketch on back) Distances from: Open Water Body >25 feet Drainage way >5 feet Possible Wet Area >25 feet Property Line >10 feet Drinking Water Well >100 feet **DEEP OBSERVATION HOLE LOG*** Surface (Inches) (USDA) (Munsell) (Structure, Stones, Boulders, Consistency, % Gravel) Soils/Urban 60-120" 2.5y 5/3

Parent Material (geologic): Till Depth to Bedrock: >120" Depth to Groundwater: 96" Standing Water in Hole: 96" Weeping from pit face: 96" Estimated Seasonal High Groundwater: 96"

MINIMUM OF 2 HOLES REQUIRED AT EVERY PROPOSED DISPOSAL AREA

DEP APPROVED FORM - 12/07/95

TEST PIT LOGS

FORM 11 - SOIL EVALUATOR FORM

Location Address or Lot No. <u>88 Worcester Street, Grafton, MA</u>


On-site Review

Deep Hole Number: TP-2 Date: 8/10/17 Time: AM Weather: Sunny 80s Location (identify on site plan)_ Slope (%) <u>0-5%</u> Surface Stones <u>None</u> Land Use Commercial Vegetation Landscaping Landform ____ Position on landscape (sketch on back) Distances from: Drainage way >5 feet Open Water Body >25 feet Possible Wet Area >25 feet Property Line <u>>10</u> feet Drinking Water Well >100 feet

| Depth from Surface (Inches) | Soil Horizon | Soil Texture (USDA) | Soil Color (Munsell) | Soil Mottling | Other (Structure, Stones, Boulders, Consistency, % Gravel) |
|--------------------------------|--------------|------------------------------|-------------------------|---------------|--|
| 0-65" | Fill | Mixed Soils/Urban Fill | | | |
| 65-120" | C | Sand | 2.5y 5/3 | | 그 가를 받아내일만 했다. |
| | | | | | |
| | | | | | |
| | | | | | |
| | | | | | |

Parent Material (geologic): Till Depth to Bedrock: >120" Depth to Groundwater: 96" Standing Water in Hole: 96" Weeping from pit face: 96" Estimated Seasonal High Groundwater: 96"

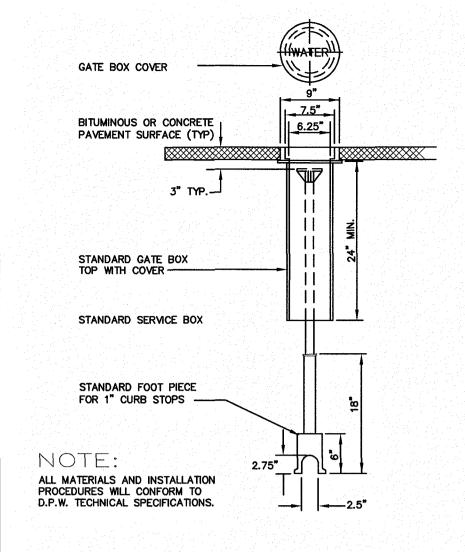
DEP APPROVED FORM - 12/07/95





SERVICE BOX INSTALLATION IN PAVEMENT

WITH LESS THAN 6' OF COVER

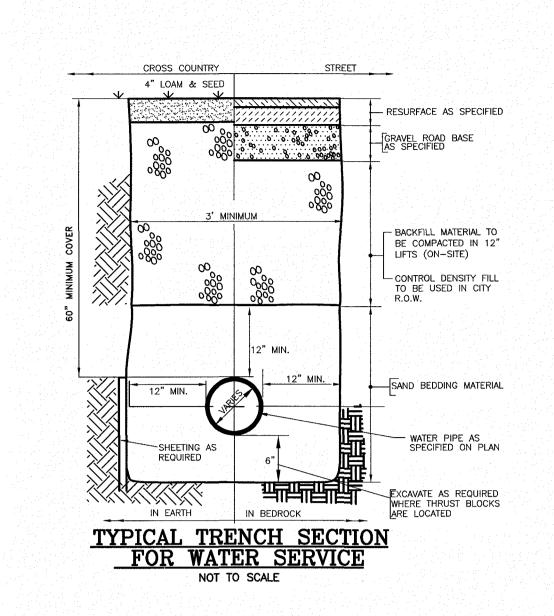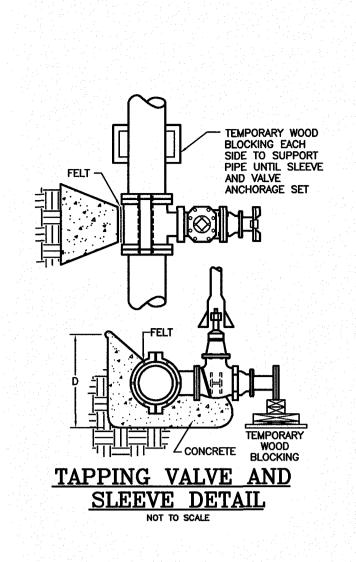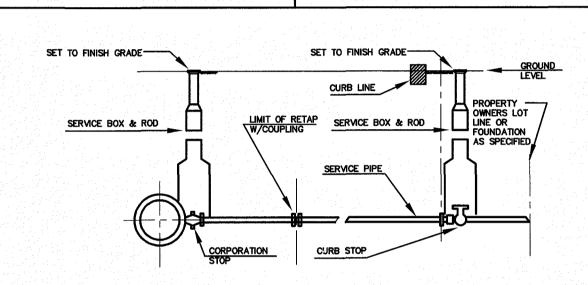
NOT TO SCALE









TYPICAL WATER SERVICE CONNECTION

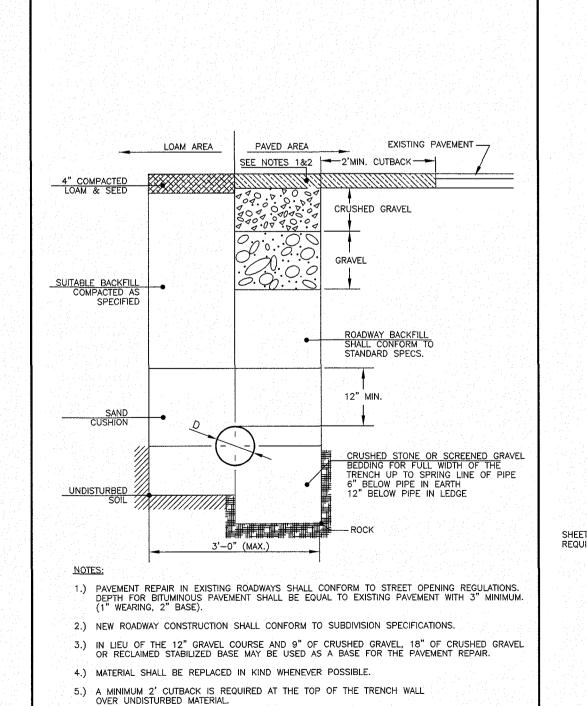

TYPICAL SEWER TRENCH DETAIL

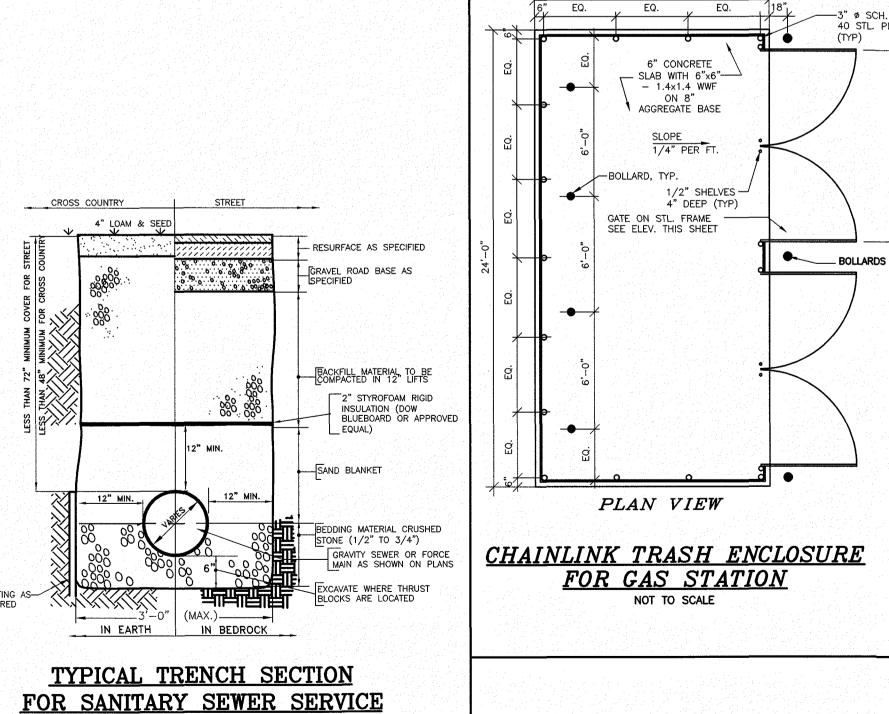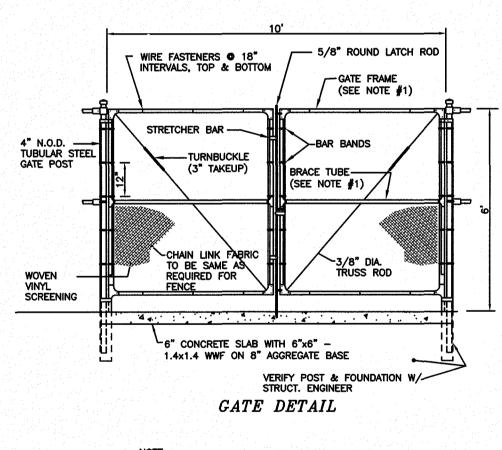NOT TO SCALE





NOTE:

1) NOMINAL OUTSIDE DIAMETER (N.O.D.) OF GATE FRAME AND BRACE TUBE TO BE 1.66" UP TO 6" IN WIDTH, AND 1.90" IF OVER 6' IN WIDTH.


| NO. | DESCRIPTION | В | BY DATE | |
|-----|-------------|---|---------|---|
| | REVISIONS | | | |
| | | | | _ |

DETAIL SHEET

ASSESSORS MAP 55 LOT 94 88 WORCESTER STREET GRAFTON, MASSACHUSETTS

PREPARED FOR: PETROGAS GROUP NEW ENGLAND, INC.

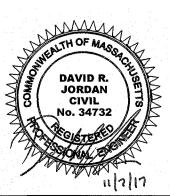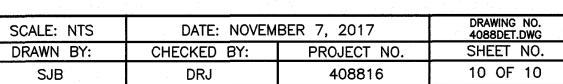
168 NORTH MAIN STREET ANDOVER, MASSACHUSETTS 01810



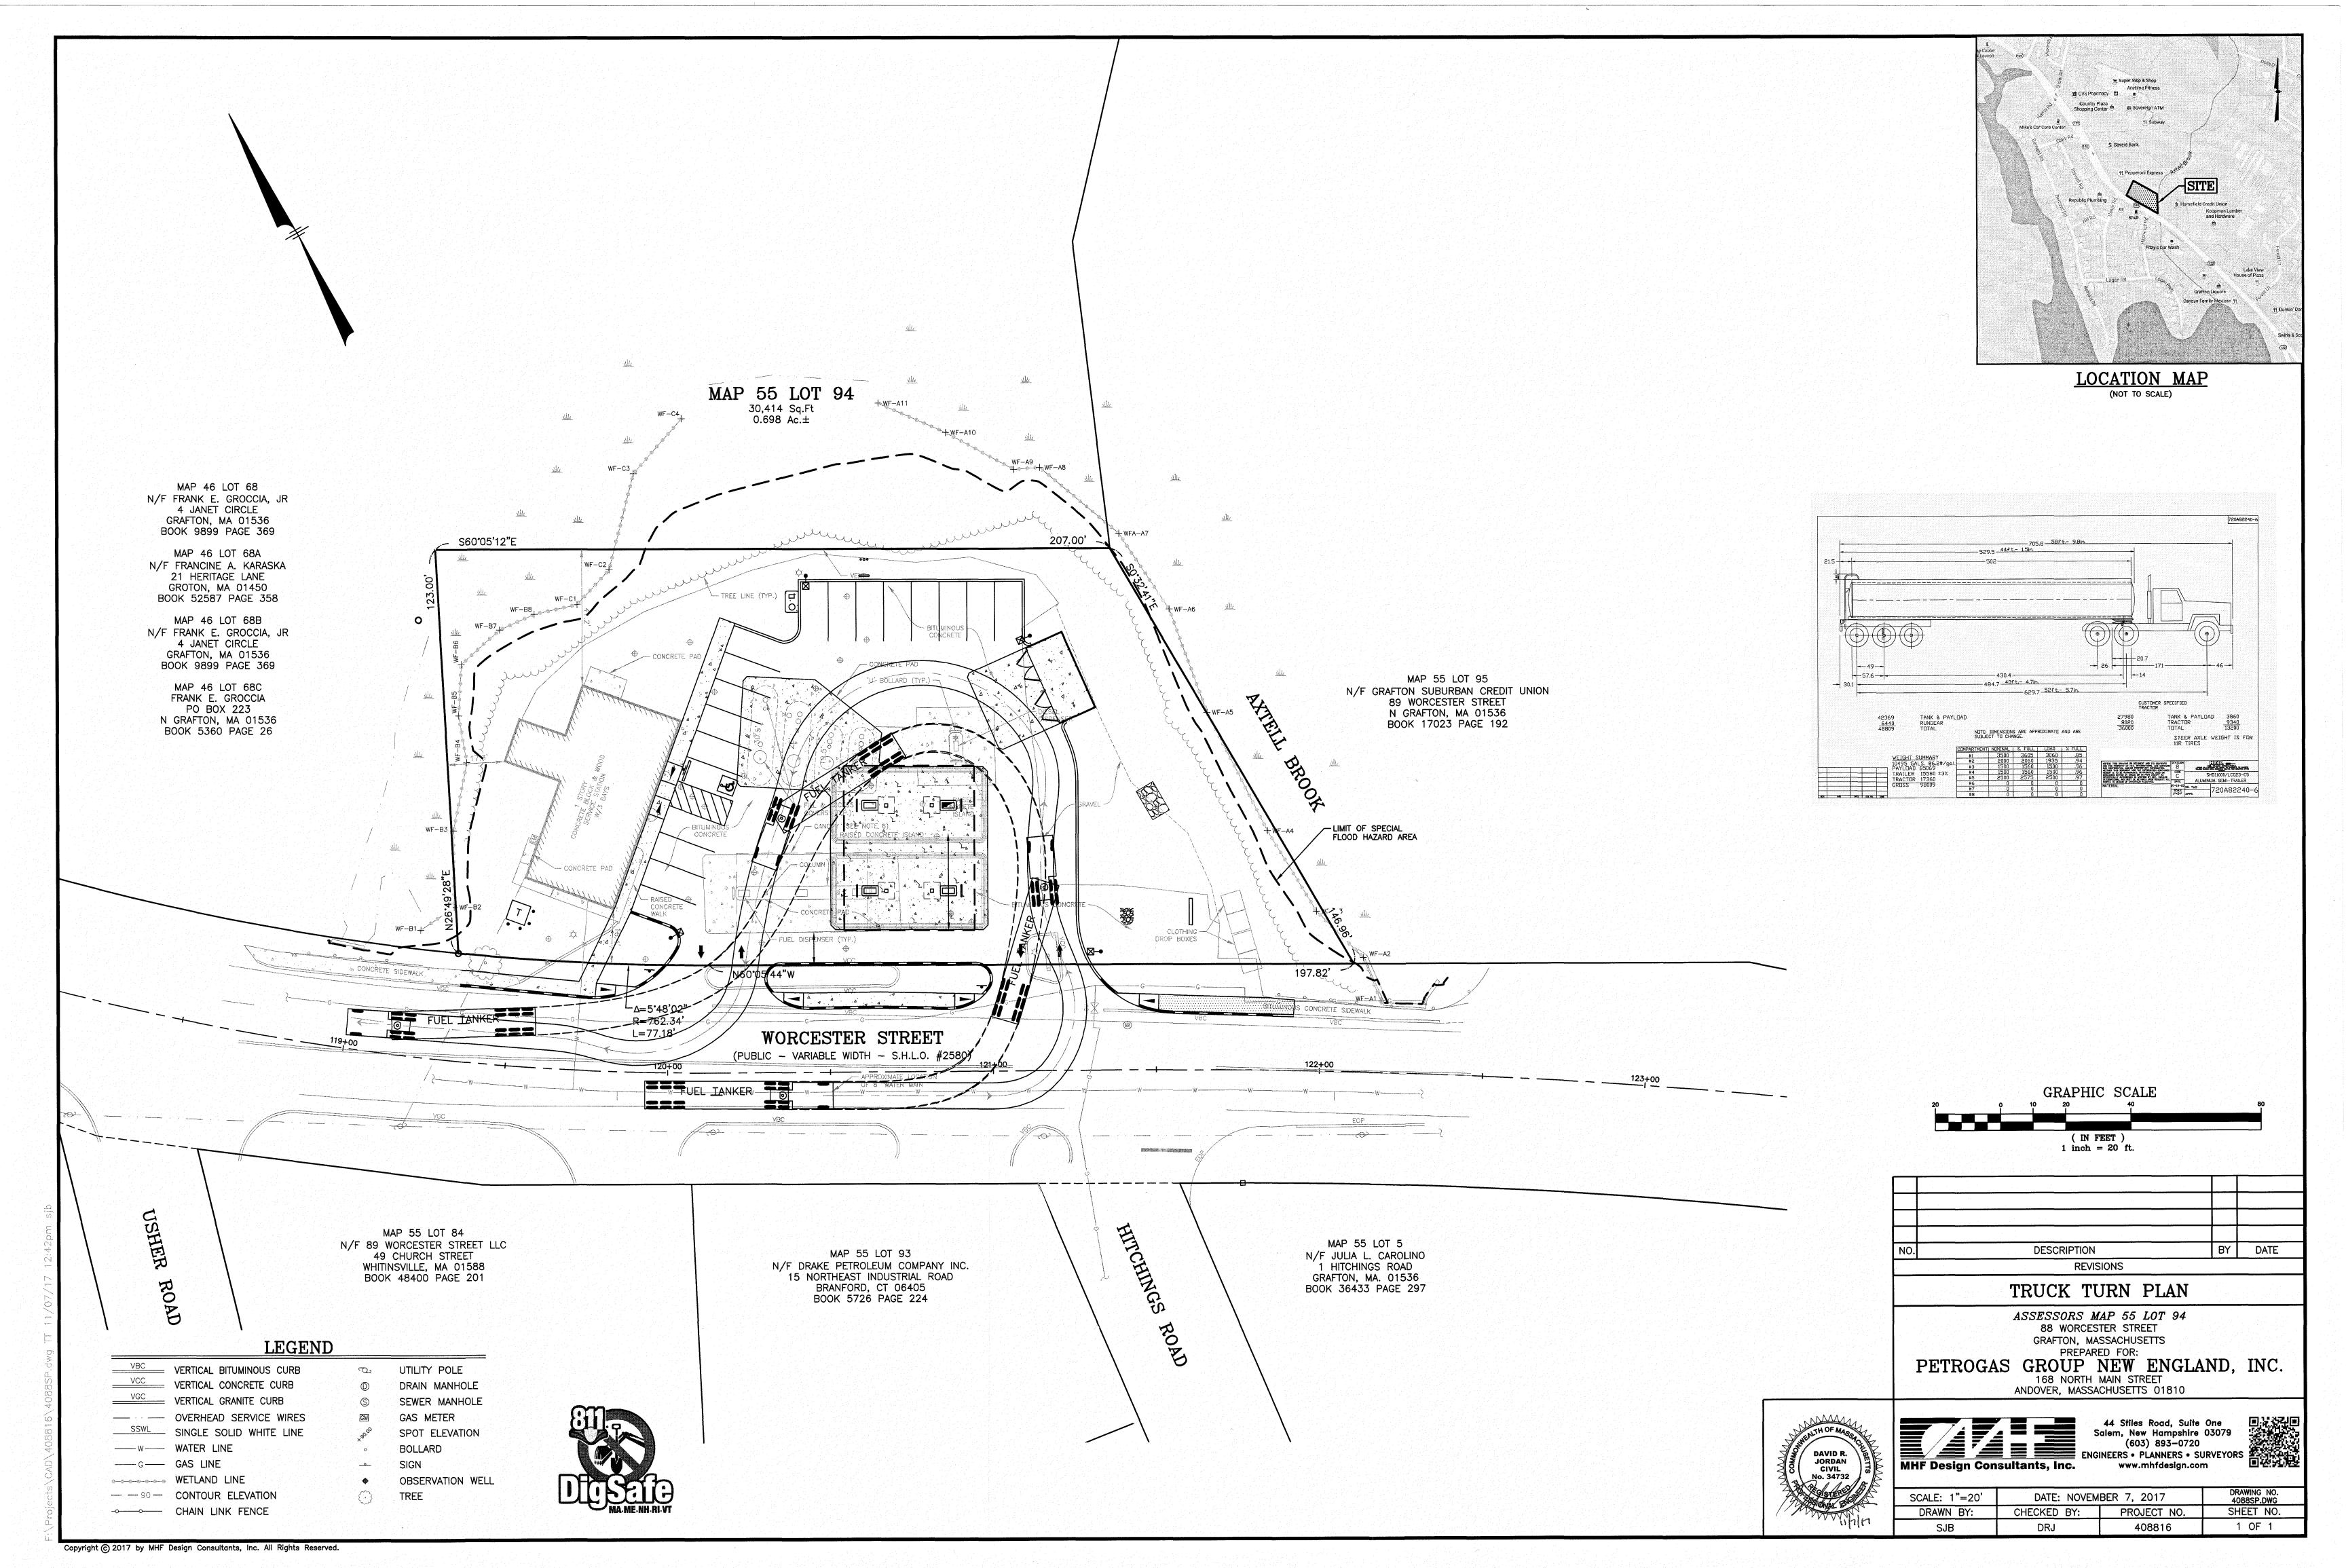


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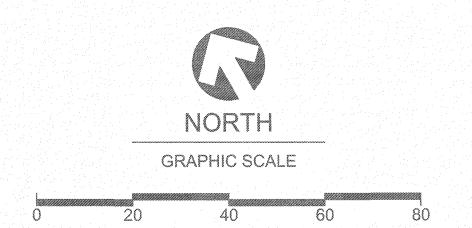


1340 Kemper Meadow Dr. | Cincinnati, OH 45240 | 513-574-9500

www.redleonard.com

ALL AREA LIGHTS SHALL BE MOUNTED TO 15 FT. POLES ON 2 FT. CONCRETE BASES.

| | | A.F.Y. |
|--------|-------|-----------------|
| LUM NO | LABEL | MOUNTING HEIGHT |
| 1 | A4 | 17 |
| 2 | A4 | 17 |
| 3 | A4 | 17 |
| 4 | A4 | 17 |
| 5 | C9 | 15.5 |
| 6 | C9 | 15.5 |
| 7 | C9 | 15.5 |
| 8 | C9 | 15.5 |
| 9 | C9 | 15.5 |
| 10 | C9 | 15.5 |
| 11 | C9 | 15.5 |
| 12 | C9 | 15.5 |
| 13 | C9 | 15.5 |
| 14 | C9 | 15.5 |
| 15 | C9 | 15.5 |
| 16 | C9 | 15.5 |
| 17 | W3 | 12 |
| 18 | W3 | 12 |
| 19 | W3 | 12 |
| 20 | W3 | 12 |
| 21 | W3 | 12 |
| 22 | W3 | 12 |



| FOOTCANDLE LEVELS CALCULATED AT GRADE US | | 0.25 | | | |
|--|-------|------|-----|---------|---------|
| LABEL | AVG | MAX | MIN | AVG/MIN | MAX/MIN |
| SITE PAVED AREA | 5.50 | 15.9 | 1.3 | 4.23 | 12.23 |
| UNDEFINED | 0.45 | 6.7 | 0.0 | N.A. | N.A. |
| UNDER CANOPY | 43.53 | 58 | 29 | 1.50 | 2.00 |

SCALE: LAYOUTBY

7/26/17

| LUMINAIRESCHE | 300 (5) | | | | | | | | |
|---------------|----------------|-------|-------------|--------|-------|------------|-------------|--------------|---------------------------|
| SYMBOL | QTY | LABEL | ARRANGEMENT | LUMENS | LLF | ARR. WATTS | TOTAL WATTS | MANUFACTURER | DESCRIPTION |
| | 4 | A4 | SINGLE | 10443 | 1.030 | 101 | 404 | CREE, INC. | BXSP-B-HT-4ME-B-57K-UL-XX |
| | 12 | C9 | SINGLE | 12406 | 1.030 | 96.31 | 1155.72 | CREE, INC. | CPY250-B-DM-D-B-UL-XX-57K |
| | 6 | W3 | SINGLE | 4031 | 1.030 | 42.96 | 257.76 | CREE, INC. | XSPWA03MC-UX |

2.4 2.1 2.4 2.5 3.5

1.9 2.8 3.5 3.8 3.8

50 50 50 50 51 51 52 55 59 13 13 57 55 56 56 57 58 10 12 11 11 57 54 51 51 51 50 50 50

00 00 00 00 00 00 01 01 01 02 03 03 02 02 02 03 03 02 02 02 01 01 01 00 00 00 00 00

(PUBLIC - VARIABLE WIDTH - S.H.L.O. #2580)

0.9 0.2 0.1

2.9 4.8 3.7 3.2 18 107 0.0 0.0 0.0

[†]14.6 [†]4.9

15.9 [†]6.1

14.5 7.7

10.3 6.3

3.5 4.4 3.5

3.5 3.9 5.0 2.1 1.7

0.0 0.1 0.2

0.1 0.1 0.4

0.0 0.1 0.2

0.0 0.1 0.1

1.4 3.6 5.4


0.9

1.1 2.9


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1.0 2.4 4.6 5.9 3.3



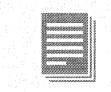


AREA

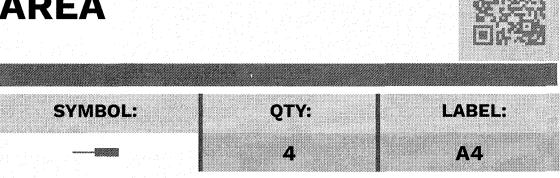


BXSP-B-HT-4ME-B-57K-UL-XX



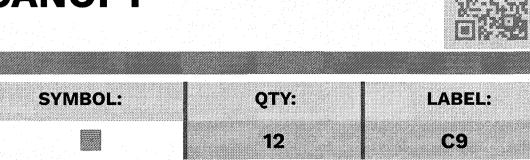


CPY250-B-DM-D-B-UL-XX-57K

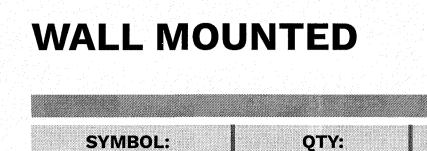


LABEL:

W3

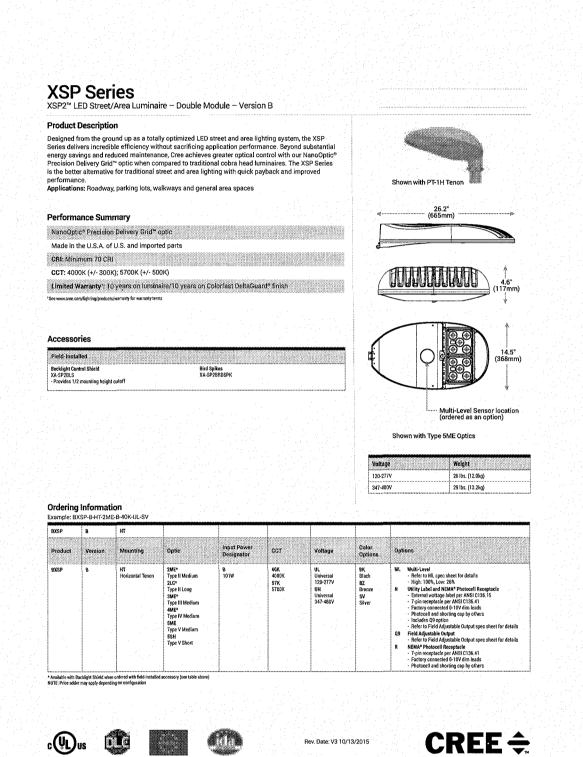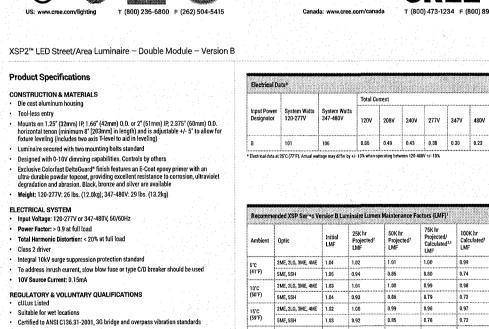XSPWA03MC-UX





Meets CALTrans 611 Vibration testing

10kV surge suppression protection tested in accordance with IEEE/ANSI C62.41.2
 Meets FCC Part 15 standards for conducted and radiated emissions

Meets Buy American requirements within ARRA
 DLC qualified. Exceptions apply when N or Q9 (select adjustments) options are ordered. Please refer to www.designlights.org/QPL for most current information.

Dark Sky Friendly, IDA Approved. Please refer to www.darksky.org for most current


US: www.cree.com/lighting T (800) 236-6800 F (262) 504-5415

RoHS compliant. Consult factory for additional details


2ME, 2LG, 3ME, 4ME 1.01 0.99 5ME, 5SH 1.01 0.90

5ME, 5SH 1.00 0.89 0.82 0.76 0.70

| roduct Description e CPY250® LED Canopy/Soffit Luminaire has an extremely iminum. It can be surface mounted easily from below the rect imaging of the LEDs is eliminated with a highly efficie is. plications: Petroleum canopies, CNG fueling stations, so | canopy deck and can be pendant m | nounted. | |
|---|---|--|---|
| plications: Petroleum canopies, CNG fueling stations, so | | | |
| | fits | | |
| erformance Summary | | | |
| ssembled in the U.S.A. of U.S. and imported parts | | | Flat Lens |
| nitial Delivered Lumens: Up to 20,080 | | | |
| fficacy: Up to 151 LPW | | | |
| RI: Minimum 70 CRI | | ************************************** | |
| CT: 3000K (+/- 300K), 4000K (+/- 300K), 5700K (+/- 500K) | | | |
| imited Warranty*: 10 years on luminaire/10 years on Colo | orfast DeltaGuard® finish | | |
| P66 Rated (Direct Mount only) | | | Drop Lens |
| lass I, Division 2 Hazardous Location for select models | | | |
| e http://lighting.cree.com/warranty for warranty terms | | | |
| cessories | | | 0.91" 2.0" |
| ield-Installed | | | Drop Lens (50mm) Flat Glass Lens |
| irect Mount Luminaires anopy Ungrade Kits 118 ga. steel A-BXCCMW – for use with JetPhilips, 21.60" [549mm] square A-BXCCWW – for use with Listo Pranciscan, 22.06" [560mm] square A-BXCCWW – for use with Listo Pranciscan, 22.06" [560mm] square A-BXCCWW – for use with List Dakota or Masters, 22.50" [572mm] square A-BXCCSW – for use with List Ricchmond or Whiteway Civic, 23.00" [584] B-BXCCBW – for use with List Richmond or Whiteway Civic, 23.00" [584] B-BXCCBW – for use with List Richmond or Whiteway Civic, 23.00" [584] B-BXCCBW – 50" [152mm] H x 3/4" [19mm] NPT Stem Watertight Rated for feed through 8 [4 in, 4 out] #12 AWC conductors irect Mount Beauty Plates A-BXCCBW – 26.17" [656mm] Beauty Plate (18 ga. steel) M-BXCCBP312W – 26.17" [656mm] Beauty Plate [18 ga. steel] M-BXCCBP312W – 26.17" [656mm] Beauty Plate [18 ga. steel] M-BXCCBP316W – 26.17" [656mm] Beauty Plate [18 ga. steel] M-BXCCBP316W – 26.17" [656mm] Beauty Plate [18 ga. steel] M-BXCCBP316W – 26.17" [656mm] Beauty Plate [18 ga. steel] M-BXCCBP316W – 26.17" [656mm] Beauty Plate [18 ga. steel] M-BXCCBP316W – 26.17" [656mm] Beauty Plate [18 ga. steel] M-BXCCBP316W – 26.17" [656mm] Beauty Plate [18 ga. steel] M-BXCCBP316W – 26.17" [656mm] Beauty Plate [18 ga. steel] M-BXCCBP316W – 26.17" [656mm] Beauty Plate [18 ga. steel] M-BXCCBP316W – 26.17" [656mm] Beauty Plate [18 ga. steel] M-BXCCBP316W – 27.17" [656mm] Beauty Plate [18 ga. steel] M-BXCCBP316W – 27.17" [656mm] Beauty Plate [18 ga. steel] M-BXCCBP316W – 27.17" [656mm] Beauty Plate [18 ga. steel] M-BXCCBP316W – 27.17" [656mm] Beauty Plate [18 ga. steel] M-BXCCBP316W – 27.17" [656mm] Beauty Plate [18 ga. steel] M-BXCCBP316W – 27.17" [656mm] Beauty Plate [18 ga. steel] M-BXCCBP316W – 27.17" [656mm] Beauty Plate [18 ga. steel] M-BXCCBP316W – 27.17" [656mm] Beauty Plate [18 ga. steel] M-BXCCBP316W – 27.17" [656mm] Beauty Plate [18 ga. steel] M-BXCCBP316W – 28.17" [656mm] Beauty Plate [18 ga. steel] M-BXCCBP316W – 28.17" [656mm] Beauty Plate [18 ga. steel] M-BXCCBP316W | - Includes two conduit fittings an 3/4-14 NPT pipe threaded on to ends mm] L - Kandy Held Remote XA-SENSREM - For successful implementation programmable multi-level optiminimum of one hand-held rer is required 05mm] d for 06mm] | dant ndant ndant nd wo | Gasket to Seal J4* 119mm Conduit Entr Conduit Entr Conduit Entr Canopy Cutout 7.2" [183mm] [1.0" [382mm] Supplied Self-Sealing Sheet Metal Screws Weight [1.5 lbs. (5.7kg]] |
| | | | |
| dering Information | | | |
| dering Information Imple: CPY250-B-DM-D-A-UL-SV PY250 B | | | |

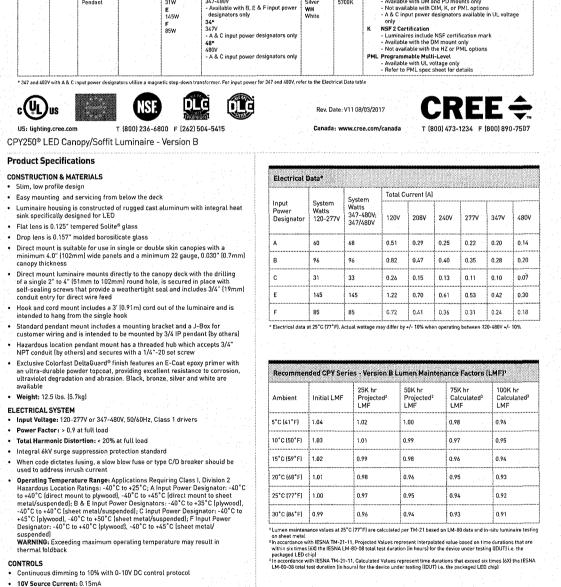

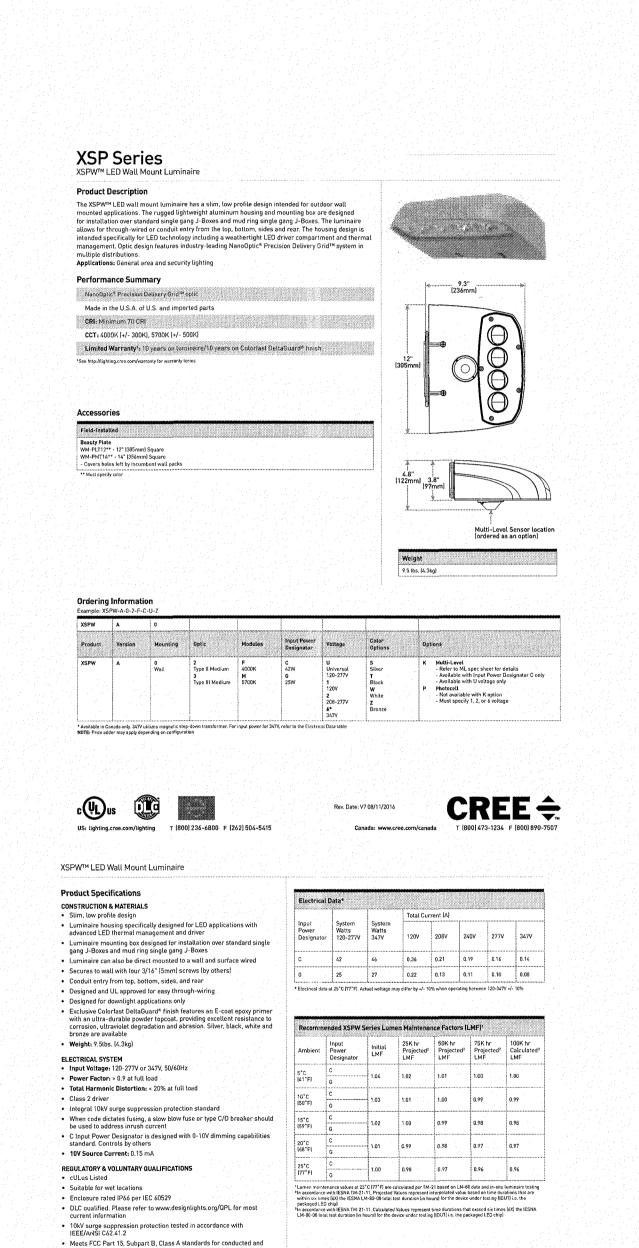Canada: www.cree.com/canada T (800) 473-1234 F (800) 890-7507



 Class I, Division 2 Hazardous Location rated when ordered with the DM or PD
mount and the HZ option. A & C input power designators are available in UL
voltage only. Not available with DIM, NSF or PML options. Rated for Groups
A, B, C & D. Bears a T3C I160*Cl temperature classification within a 25*C DLC and DLC Premium qualified versions available. Please refer to https://www.designlights.org/search/ for most current information

US: tighting.cree.com T (800) 236-6800 F (262) 504-5415

 \bullet . Use only lighting controls with neutral connection or controls intended for use with LED fixtures

Meets FCC Part 15, Subpart B, Class A standards for conducted and radiated

Reference <u>LEO Dimming spec sheet</u> for additional dimming information

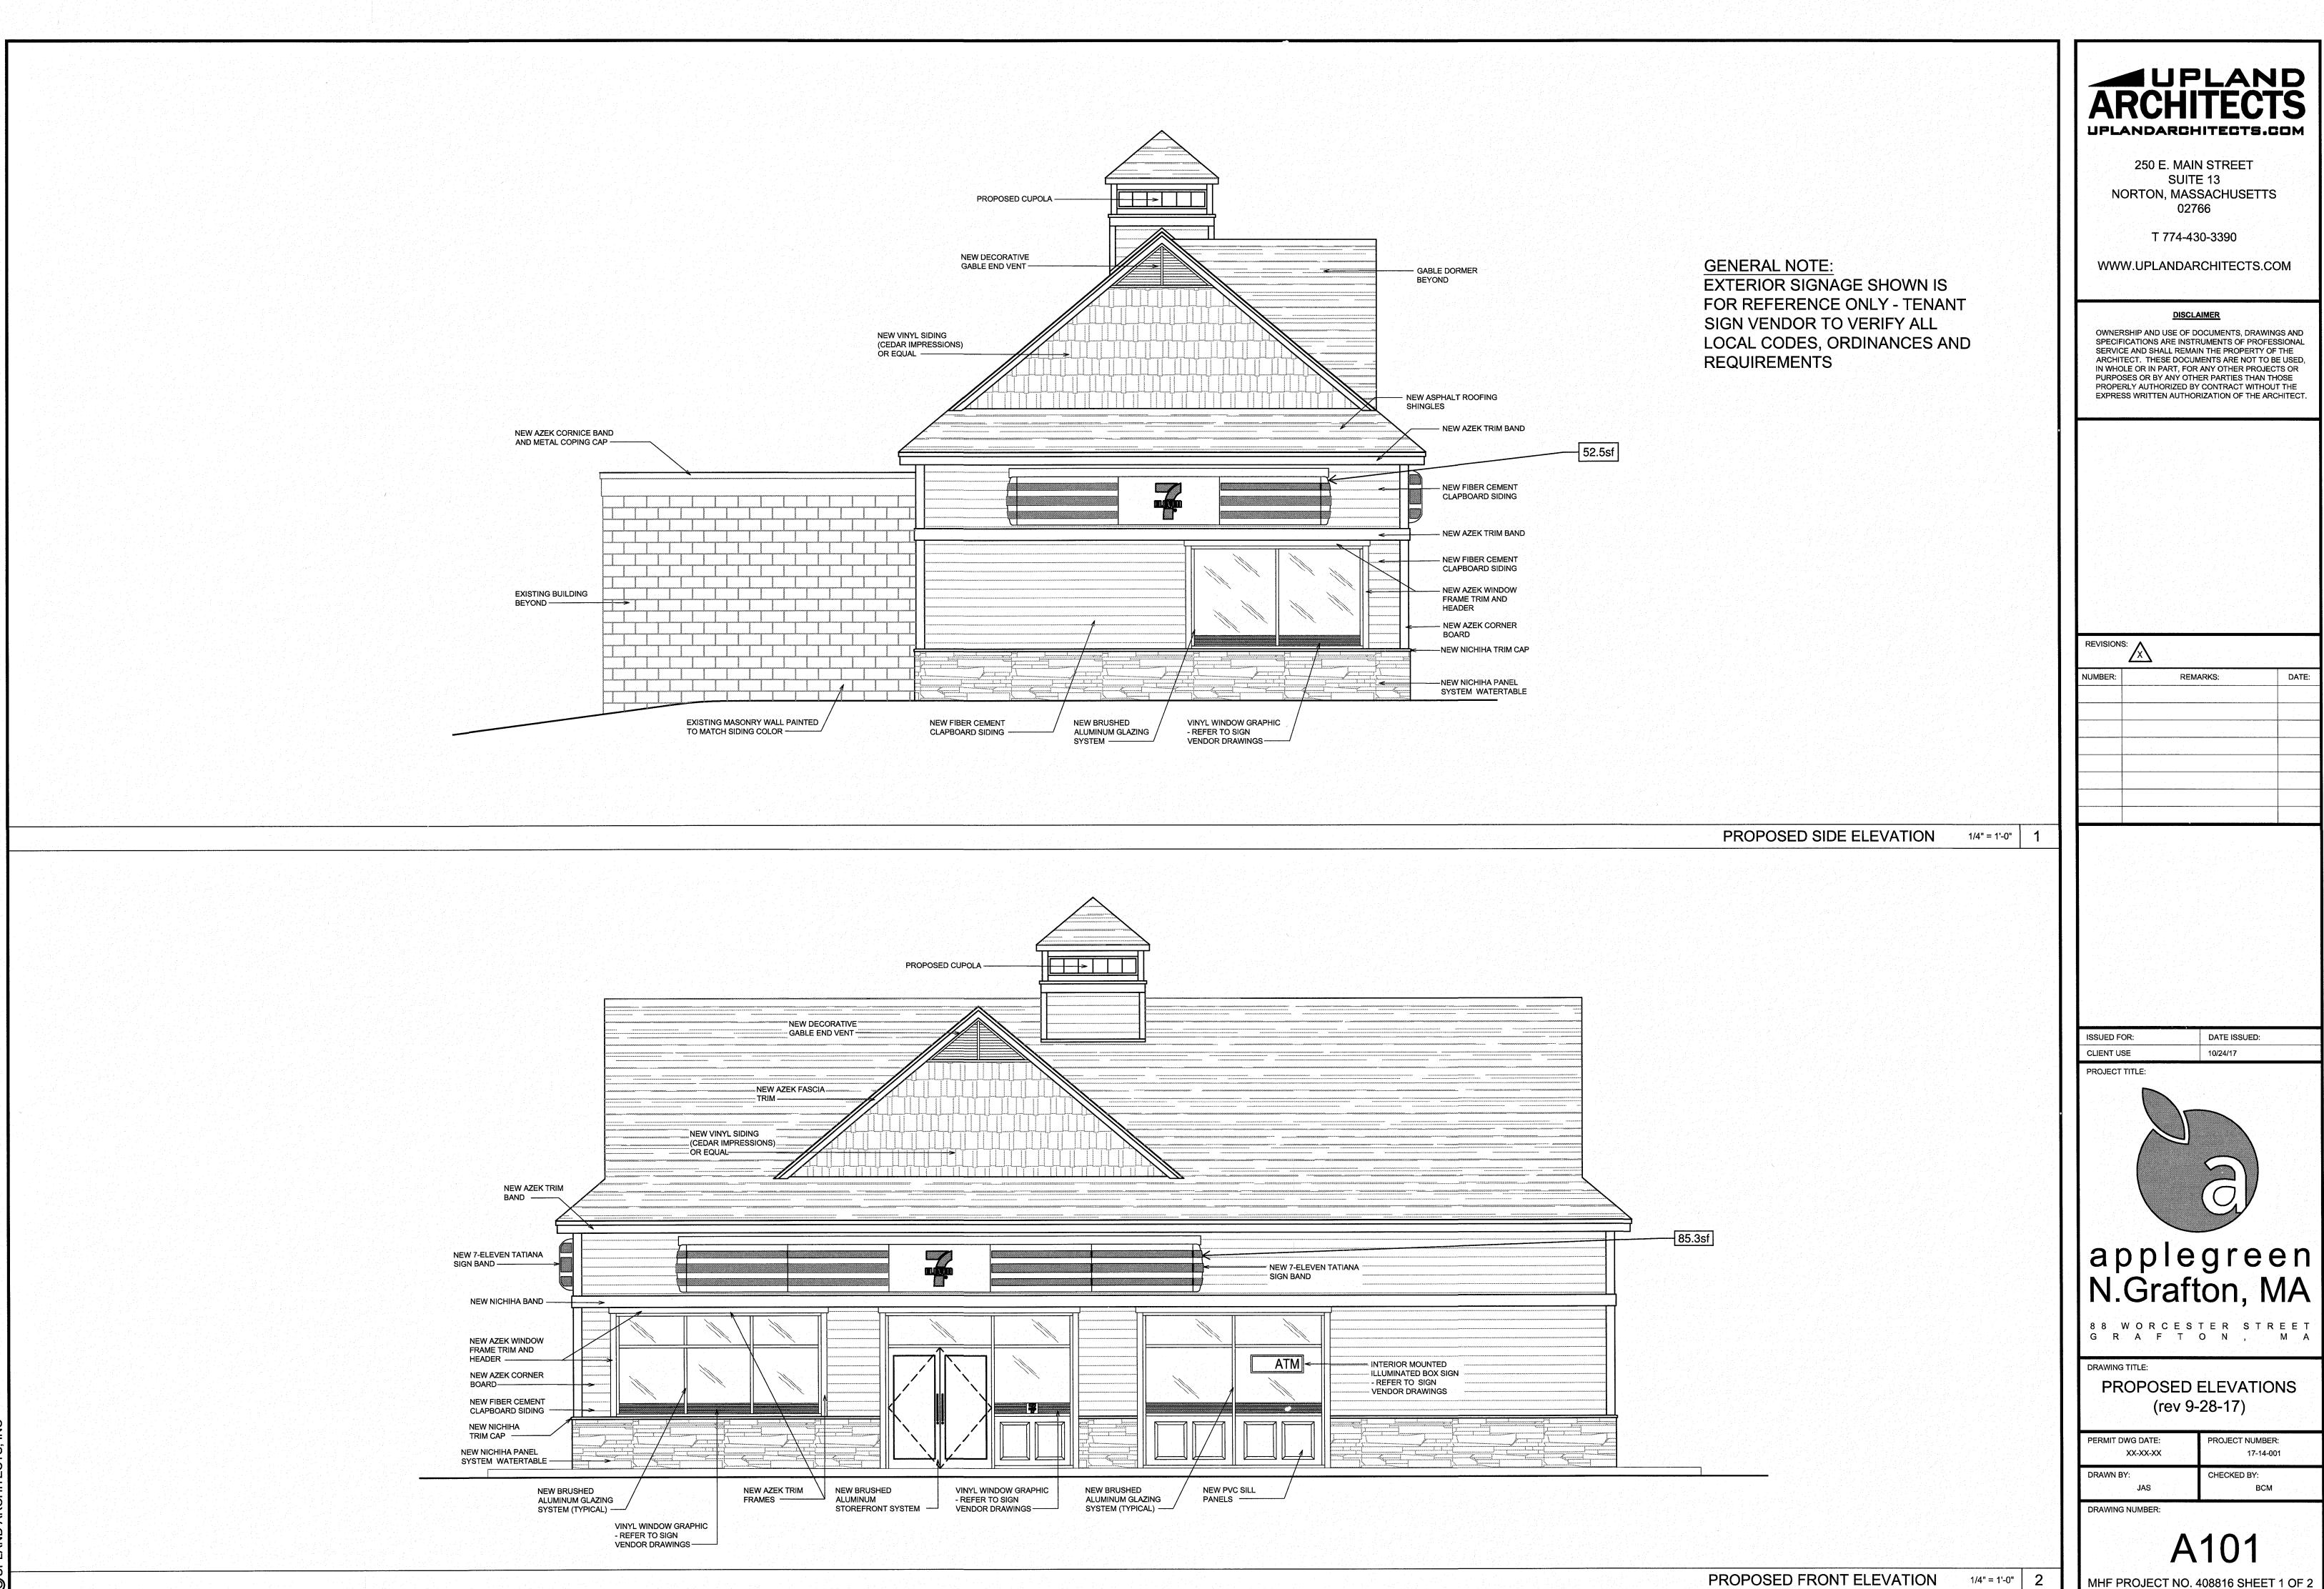
REGULATORY & VOLUNTARY QUALIFICATIONS · Suitable for wet locations when ordered with DM mount Suitable for damp locations when ordered with HC and PD mounts . Suitable for wet locations when ordered with PD mount and HZ option Enclosure rated IP66 per IEC 60529 when ordered with DM mount

Consult factory for CE Certified products

 Meets Buy American requirements within ARRA RoHS compliant. Consult factory for additional details


Meets Buy American requirements within ARRA

CONTROLS



DATE:

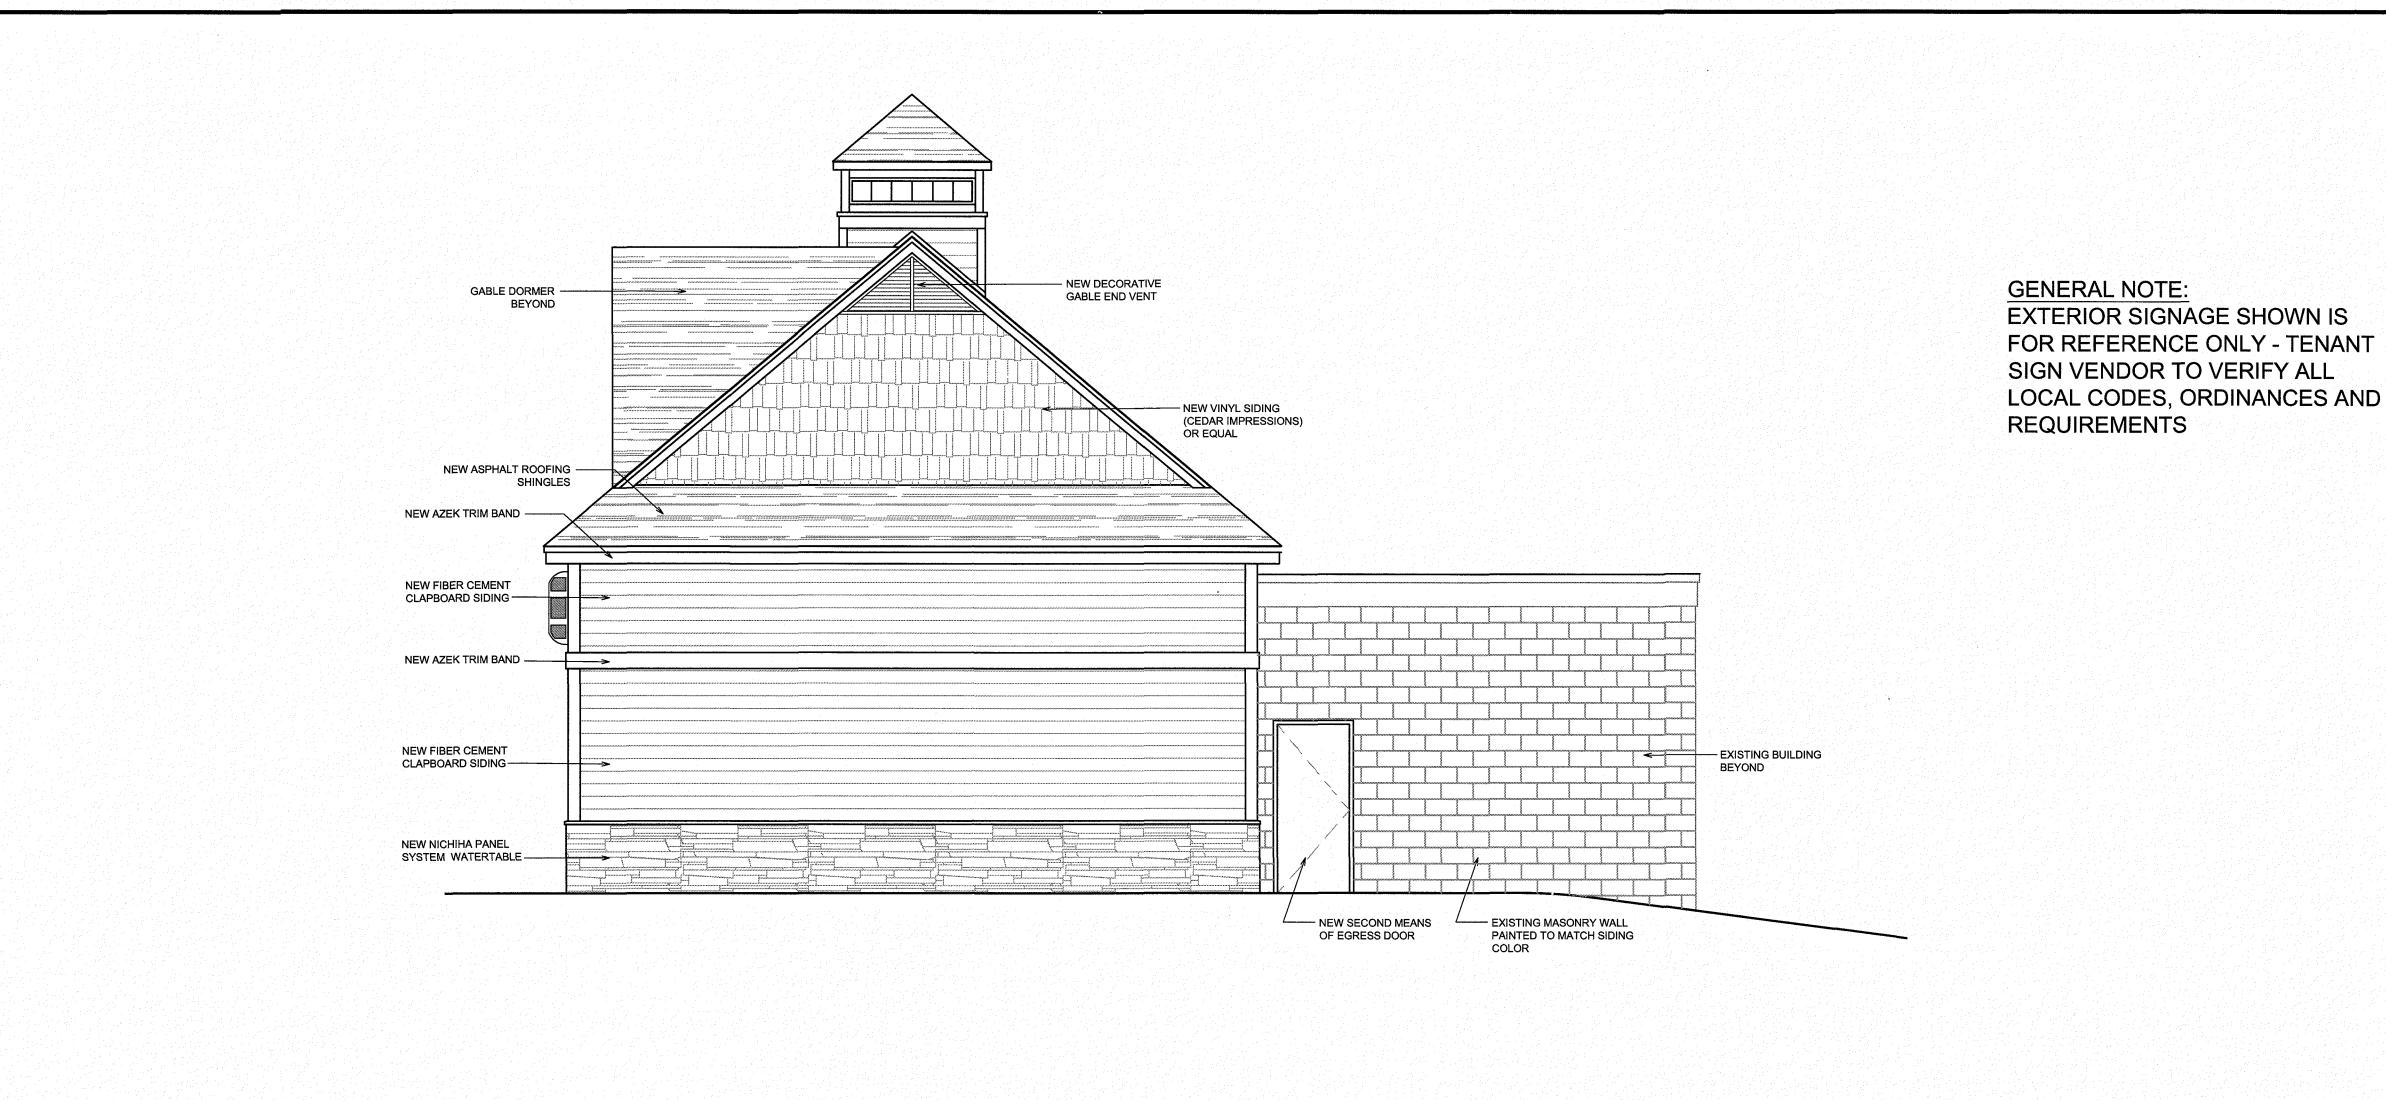1/4" = 1'-0" MHF PROJECT NO. 408816 SHEET 1 OF 2



PROPOSED FLAT ROOF AREA FOR MECHANICAL AND REFRIGERATION CONDENSING EQUIPMENT -

- EXISTING MASONRY WALL PAINTED TO MATCH SIDING

PROPOSED CUPOLA -

UPLANDARCHITECTS.COM

250 E. MAIN STREET SUITE 13 NORTON, MASSACHUSETTS 02766

T 774-430-3390

WWW.UPLANDARCHITECTS.COM

DISCLAIMER


OWNERSHIP AND USE OF DOCUMENTS, DRAWINGS AND SPECIFICATIONS ARE INSTRUMENTS OF PROFESSIONAL SERVICE AND SHALL REMAIN THE PROPERTY OF THE ARCHITECT. THESE DOCUMENTS ARE NOT TO BE USED, IN WHOLE OR IN PART, FOR ANY OTHER PROJECTS OR PURPOSES OR BY ANY OTHER PARTIES THAN THOSE PROPERLY AUTHORIZED BY CONTRACT WITHOUT THE EXPRESS WRITTEN AUTHORIZATION OF THE ARCHITECT.

| NUMBER: | REMARKS: | DATE: |
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| 11.2 | | · · · · · · · · · · · · · · · · · · · |

ISSUED FOR: CLIENT USE

PROJECT TITLE:

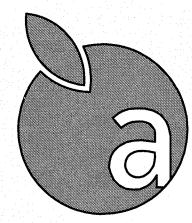1/4" = 1'-0"



DATE ISSUED:

10/24/17

applegreen N.Grafton, MA

88 WORCESTER STREET G R A F T O N , M A

DRAWING TITLE:

PROPOSED ELEVATIONS (rev 9-28-17)

PROJECT NUMBER: XX-XX-XX 17-14-001 CHECKED BY: всм

DRAWING NUMBER:

A102

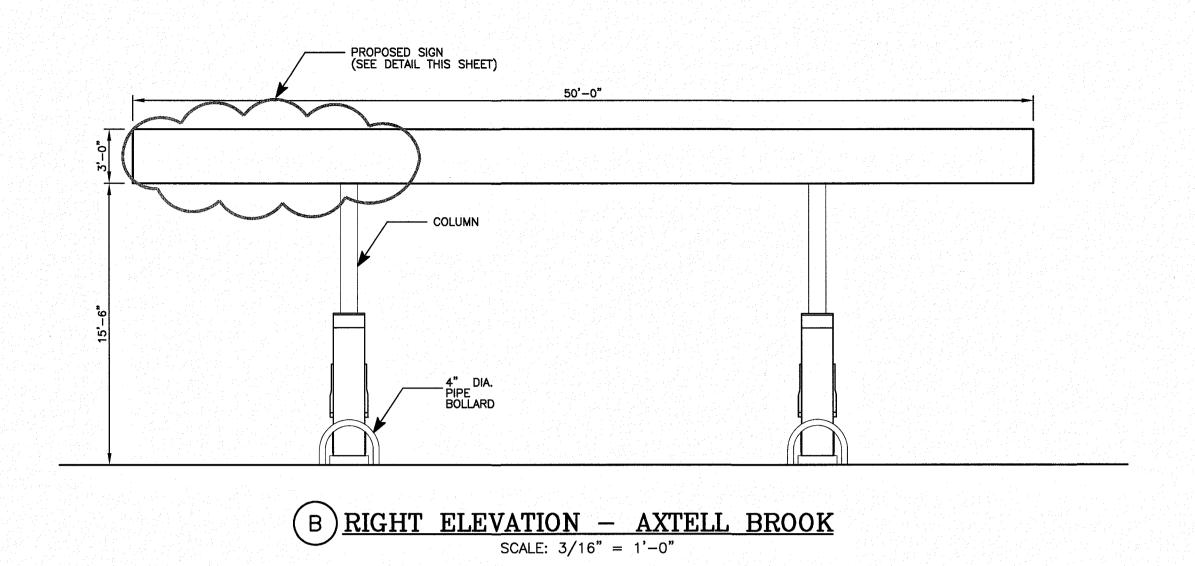
PROPOSED REAR ELEVATION

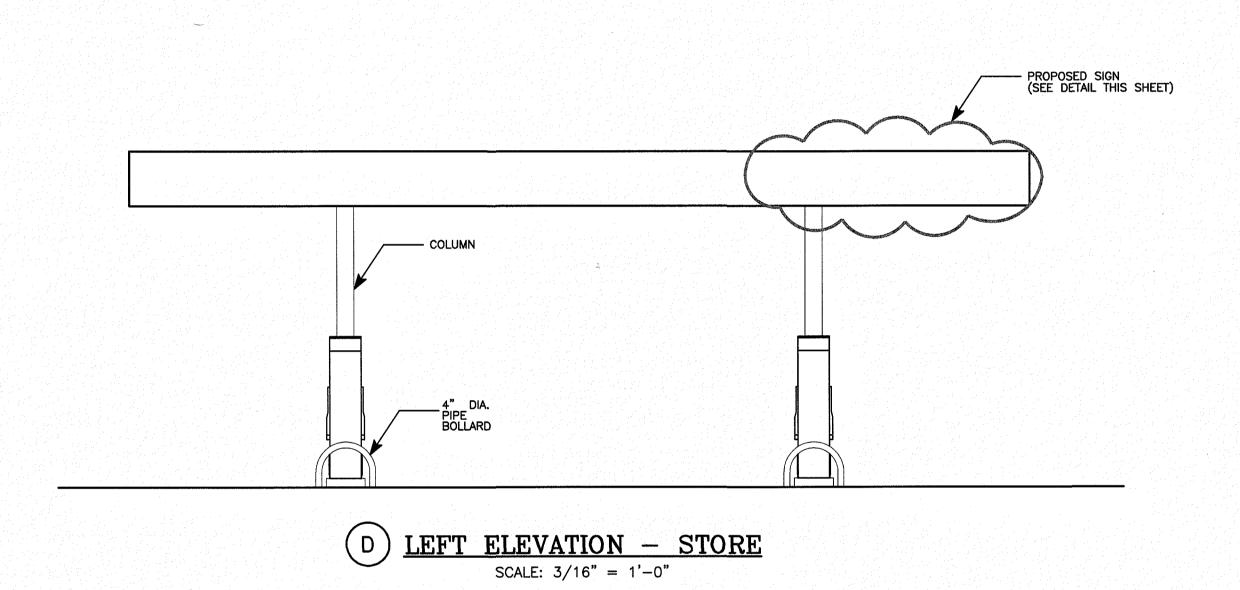
- EXISTING MASONRY WALL PAINTED TO MATCH SIDING

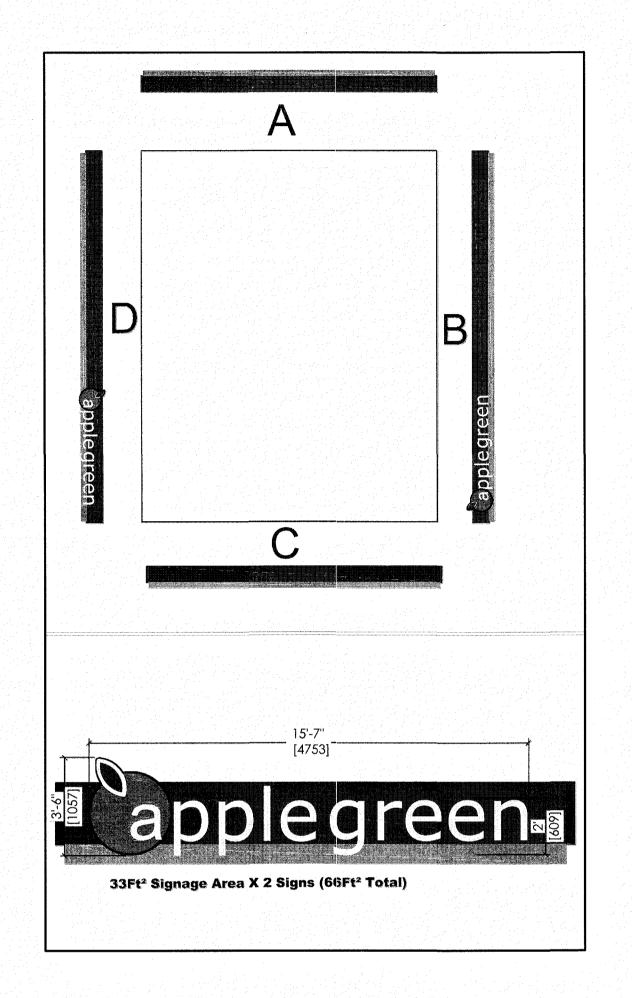
PROPOSED LEFT SIDE ELEVATION

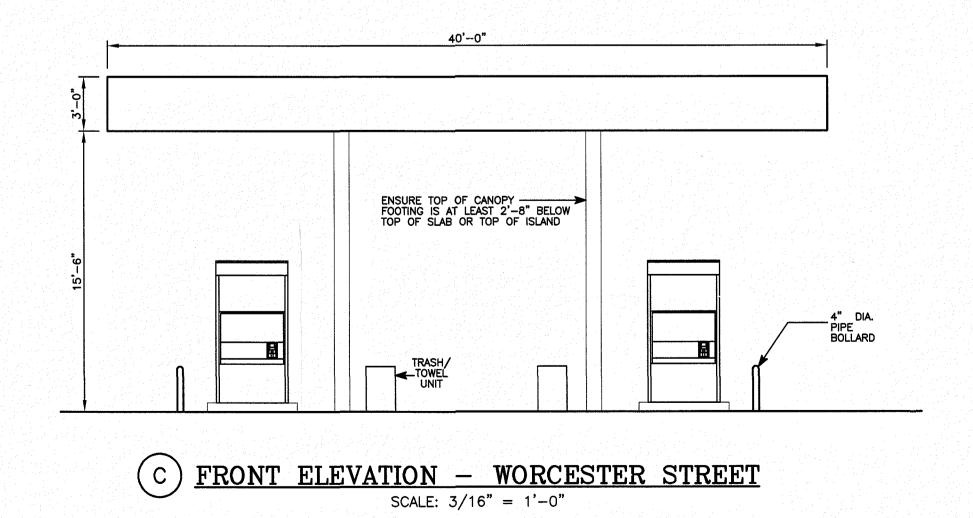
1/4" = 1'-0"

MHF PROJECT NO. 408816 SHEET 2 OF 2










ENSURE TOP OF CANOPY
FOOTING IS AT LEAST 2'-8" BELOW
TOP OF SLAB OR TOP OF ISLAND

A REAR ELEVATION - WORCESTER STREET

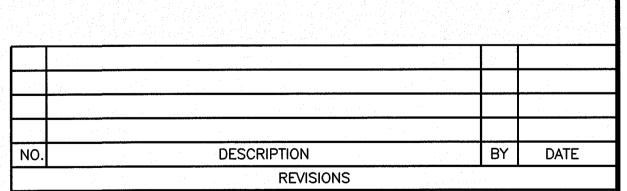
SCALE: 3/16" = 1'-0"



RETAIL FUEL CANOPY ELEVATIONS


ASSESSORS MAP 55 LOT 94

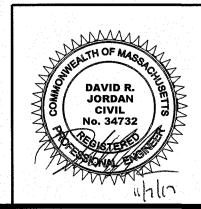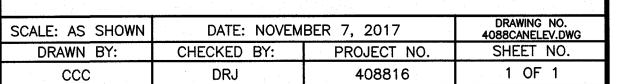88 WORCESTER STREET
GRAFTON, MASSACHUSETTS
PREPARED FOR:
PETROGAS GROUP NEW ENGLAND, INC.
168 NORTH MAIN STREET
ANDOVER, MASSACHUSETTS 01810





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Salem, New Hampshire 03079
(603) 893-0720
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